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To: City of Pitt Meadows Date: January 12, 2020

Attention: Allison Dominelli | Development Services Technician Project No.: 32334

Cc:

Reference: GEBP (Phase 3 & Phase 4) Landscape Review

From: Jose Gonzalez, MBCSLA

In response to your request, ISL reviewed the Landscape drawings submitted to the City of Pitt Meadows for the Golden Ears Business Park (GEBP) Phase 3 & Phase 4. The Landscape drawings were reviewed to ensure compliance with the City of Pitt Meadows Official Community Plan Amendment Bylaw No. 2758, 2017.

The Landscape drawings were prepared for the proposed GEBP Phase 3 & Phase 4 development; project address 11208 Harris Road. ISL reviewed two drawings packages, both prepared by Durante Kreuk Ltd. (DK):

- Golden Ears Industrial Park Phase 3 Pitt Meadows, BC Re-Issued for DP Oct 30, 2019
- Golden Ears Industrial Park Phase 4 Pitt Meadows, BC Re-Issued for DP Nov 29, 2019

In the documents attached ISL has provided comments both general and sheet specific on the Landscape drawings packages mentioned above. ISL was not able to comment on certain aspects of the landscape and site design which are incomplete at this stage such as parking layout, lighting, signage or site furnishings.

We trust you find this memorandum in accordance with your request. Should you require clarification of the content of this report or further information, please contact the undersigned at your convenience.

Sincerely,

Jose Gonzalez, MBCSLA

Attachment
32334\_GEBP\_Landscape\_ISL\_Review
GEBP Phase 3 Landscape Drawings Revised - ISL MARKUP
GEBP Phase 4 Landscape Drawings - ISL MARKUP

Design Review		
Reviewing Firm: ISL Reviewer: Jose Gonzalez, Landscape Architect, MBCS		Date: 2020-01-08
Project Name: Golden Ears Business Park (GEBP) Phase 3 & Phase 4, Pitt Meadows, BC		Stage: Issued for DP review
Review Discipline: Landscape Architecture		Revision: 0


	Golden Ears Industrial Park – Phase 3 – Pitt Meadows, BC – Re-Issued for DP – Dec 19, 2019			
#	Reference Dwg/ Specification	Review Comment	Response	
	<b>3</b> , 1, 1	Ensure the end of each single row of parking stalls has a tree and a		
1	General Comment	landscaped island between the end of the parking stall and the		
		adjacent drive aisle, as per OCP.		
		Parking spaces should be designed in a way that a portion of the		
		vehicle hangs over into a landscaped strip where possible, as per		
2	General Comment	OCP. We recommend a bio-swale/rain garden strip be added		
		between single rows of parking (front-to-front) for stormwater runoff		
		infiltration		
2	Canada Caranaat	Use Landscaping to identify entrances to the site and buildings, as per		
3	General Comment	OCP		
4	General Comment	Site layout and parking design seems incomplete, as well as		
7	General Comment	landscape lighting and signage.		
5	General Comment	Insufficient outdoor amenity space, refer to OCP - 7 Employee &		
	deficial comment	Community Amenity		
		Landscape beds for the trees in the parking rows seem to be		
		insufficient (5.00m x 1.00m approx.) to provide the minimum		
6	General Comment	requirement of 10 cubic meter per tree (unless other methods are		
		utilized such as soil cells or structural soil).		
7	L-0	MATERIAL LEGEND - Remove reference to asphalt path on the Catch		
		basin description		
8	L-0	MATERIAL LEGEND - Ensure detail callouts refer to the correct detail		
		DIANTUCT Cubatitute Cellure unlessie (houd to maintain) avecated		
9	L-0	PLANT LIST - Substitute Calluna vulgaris (hard to maintain) suggested		
		alternate Spirea Douglasii		
10	L-0	GENERAL NOTES - Update B.C. Landscape Standards reference to Canadian Landscape Standards		
		PLANTING NOTES - Note 7 - All offsite "and onsite" should have a		
		minimum of 15 cubic meters of available imported growing medium.		
11	L-0	Trees in parking areas can have 10 cubic meters as per the OCP		
		Amendments.		
		SOIL PREPARATION NOTES - Note 2 - Submit soil fertility analysis, not		
12	L-0	sieve analysis.		
		Provide landscaped islands with tree at the end of the isolated row of		
13	L-3	6 parking spaces		
1.1	1.4	Improve visibility around the picnic area (CPTED). Substitute Spruce		
14	L-4	trees with high canopy tree species.		
15	L-5	Provide landscape screening around Pump Building, as required in		
13	L-3	the OCP		
16	L-5	Use Landscaping to identify entrances to the site and buildings.		
10	L-3			
17	L-6	Provide Landscaped strip along the proposed amenity land dedication		
		edge for car overhang and runoff infiltration		
18	L-7	Distance between landscaped islands to be 18m. max		
19	L-7	Provide landscaped islands with tree at the end of the isolated row of		
		6 parking spaces		
20	L-8	Distance between landscaped islands to be 18m. max		
21	L-9	Provide landscape strip for car overhang and infiltration		
22	L-9	Use landscaping to identify entrances to the site		
23	L-9	Provide landscaped islands with tree at the end of all parking rows		
24	L-10	use landscaping to identify entrances to the building		
24	F-10	Provide landscaped islands with tree at the end of all parking rows		
25	L-10	Trovide landscaped islands with thee at the end of all parking fows		
26	L-11	Use landscaping to identify entrances to the building		
20	L'11	Tose idinascuping to identity end directions to the building		

	Golden Ears Industrial Park – Phase 3 – Pitt Meadows, BC – Re-Issued for DP – Dec 19, 2019			
#	Reference Dwg/ Specification	Review Comment	Response	
27	L-11	Ensure the single catch basin has sufficient capacity for the length and catchment of the bio-swale		
28	L-11	Adjust planting hatching along bio-swale, hard to read		
29	L-12	Use landscaping to identify entrances to the site and building		
30	Cross Sections	Growing medium depths seem to be insufficient in order to provide the minimum requirement of 15 cubic meters per tree as per the Design Guidelines. The 3' depth tree pit should extend to approximately the extent of the drip zone of the tree.		
31	Cross Sections	Avoid woody shrubs within the SRW		
32	Ld-1 / L-16	Typical tree planting notes - provide min. 15 cubic meters of imported growing medium per tree. Update chart accordingly.		
33	Ld-1 / L-16	increase Mulch over from 50mm to 75mm on trees and shrubs.		
34	Ld-1 / L-16	Remove reference to 'Screened growing medium". Use Growing Medium specification as per Canadian Landscape Standards instead (e.g. Growing Medium Type 2P)		
35	Ld-4 / L-16	Hydroseed on 6" of growing medium, not 8"		
36	Ld-6 / L-16	Remove reference to "play area"		
37	Ld-7 / L-16	Increase asphalt depth to 3" if vehicular access is foreseen for maintenance.		
38	Ld-3 (Ld-9) / L-16	Provide specifically engineered biofiltration media along bio-swale (ECOmedia by Veratec or similar.)		
39	Ld-3 (Ld-9) / L-16	Ensure Bioswale detail is coordinated with Civil		

Design Review		
Reviewing Firm: ISL	Reviewer: Andrew Robertson, Landscape Architect, MBCSLA	Date: 2020-01-08
Project Name: Golden Ears Business Park (GEBP) Phase 3 & Phase 4, Pitt Meadows, BC		Stage: Issued for DP review
Review Discipline: Landscape Architecture		Revision: 0

	Golden Ears Industrial Park – Phase 4 – Pitt Meadows, BC – Re-Issued for DP – Nov 29, 2019			
#	Reference Dwg/ Specification			
		Ensure the end of each single row of parking stalls has a tree and a		
1	General Comment	landscaped island between the end of the parking stall and the		
		adjacent drive aisle, as per OCP.		
_	Cara and Carana and	Use Landscaping to identify entrances to the site and buildings, as per		
2	General Comment	OCP		
		Landscape beds for the trees in the parking rows seem to be		
		insufficient (5.00m x 1.00m approx.) to provide the minimum		
3	General Comment	requirement of 10 cubic meter per tree (unless other methods are		
		utilized such as soil cells or structural soil).		
4	General Comment	Minimize length of crosswalks to improve walkability.		
5	General Comment	Use Landscaping to identify entrances to the site and buildings, as per		
		OCP		
6	L-0	GENERAL NOTES - Update B.C. Landscape Standards reference to		
		Canadian Landscape Standards PLANTING NOTES - Note 7 - All offsite "and onsite" should have a		
		minimum of 15 cubic meters of available imported growing medium.		
7	L-0	Trees in parking areas can have 10 cubic meters as per the OCP		
		Amendments.		
		SOIL PREPARATION NOTES - Note 2 - Submit soil fertility analysis, not		
8	L-0	sieve analysis.		
9	L-0	add north arrow		
10	L-0 L-1	add north arrow		
11	L-1	introduce trees and landscaped areas along main N-S road.		
-11	L-I	provide breaks in planting for access path to the foot path (desire		
12	L-2	lines)		
13	L-2	relocate picnic area to location with better visibility (CPTED)		
14	L-3	Use Landscaping to identify entrance to the site, as per OCP		
15	L-4	Use Landscaping to identify entrance to the site, as per OCP		
16	L-4	Use Landscaping to identify entrance to the building, as per OCP		
		Ensure the end of each single row of parking stalls has a tree and a		
17	L-5	landscaped island between the end of the parking stall and the		
17		adjacent drive aisle, as per OCP.		
		provide breaks in planting for access path to the foot path (desire		
18	L-6	lines)		
		Ensure the end of each single row of parking stalls has a tree and a		
19	L-6	landscaped island between the end of the parking stall and the		
	-	adjacent drive aisle, as per OCP.		
20	L-6	introduce trees and landscaped areas along main N-S road.		
21	L-7	introduce trees and landscaped areas along main N-S road.		
22	L-8	Use Landscaping to identify entrance to the building, as per OCP		
23	L-8	introduce trees and landscaped areas along main N-S road.		
	- <del></del>	Ensure the end of each single row of parking stalls has a tree and a		
24	L-9	landscaped island between the end of the parking stall and the		
		adjacent drive aisle, as per OCP.		
25	L-9	Use Landscaping to identify entrance to the site, as per OCP		
26	L-9	Use Landscaping to identify entrance to the building, as per OCP		
20	L-3			
27	L-10	provide breaks in planting for access path to the foot path (desire		
		Use Landscaping to identify entrance to the building, as per OCP		
28	L-10	ose candscaping to identify entrance to the building, as per OCP		
		<u> </u>		

	Golden Ears Industrial Park – Phase 4 – Pitt Meadows, BC – Re-Issued for DP – Nov 29, 2019			
#	Reference Dwg/ Specification	Review Comment	Response	
29	L-12	Use Landscaping to identify entrance to the building, as per OCP		
30	L-12	Provide a landscaped island with a tree every 6 parking spaced as per OCP		
31	L-13	Provide a landscaped island with a tree every 6 parking spaced as per OCP		
32	L-13	Use Landscaping to identify entrance to the building, as per OCP		
33	L-14	Provide formal access from the parking to the picnic areas		
34	L-15	Provide a landscaped island with a tree every 6 parking spaced as per OCP		
35	Cross Sections	Growing medium depths seem to be insufficient in order to provide the minimum requirement of 15 cubic meters per tree as per the Design Guidelines. The 3' depth tree pit should extend to approximately the extent of the drip zone of the tree.		
36	Ld-1 / L-16	typical tree planting notes - provide min. 15 cubic meters of imported growing medium per tree. Update chart accordingly.		
37	Ld-1 / L-16	increase Mulch over from 50mm to 75mm on trees and shrubs.		
38	Ld-1 / L-16	Remove reference to 'Screened growing medium". Use Growing Medium specification as per Canadian Landscape Standards instead (e.g. Growing Medium Type 2P)		
39	Ld-4 / L-16	Hydroseed on 6" of growing medium, not 8"		
40	Ld-6 / L-16	Remove reference to "play area"		
41	Ld-7 / L-16	Increase asphalt depth to 3" if vehicular access is foreseen for maintenance.		

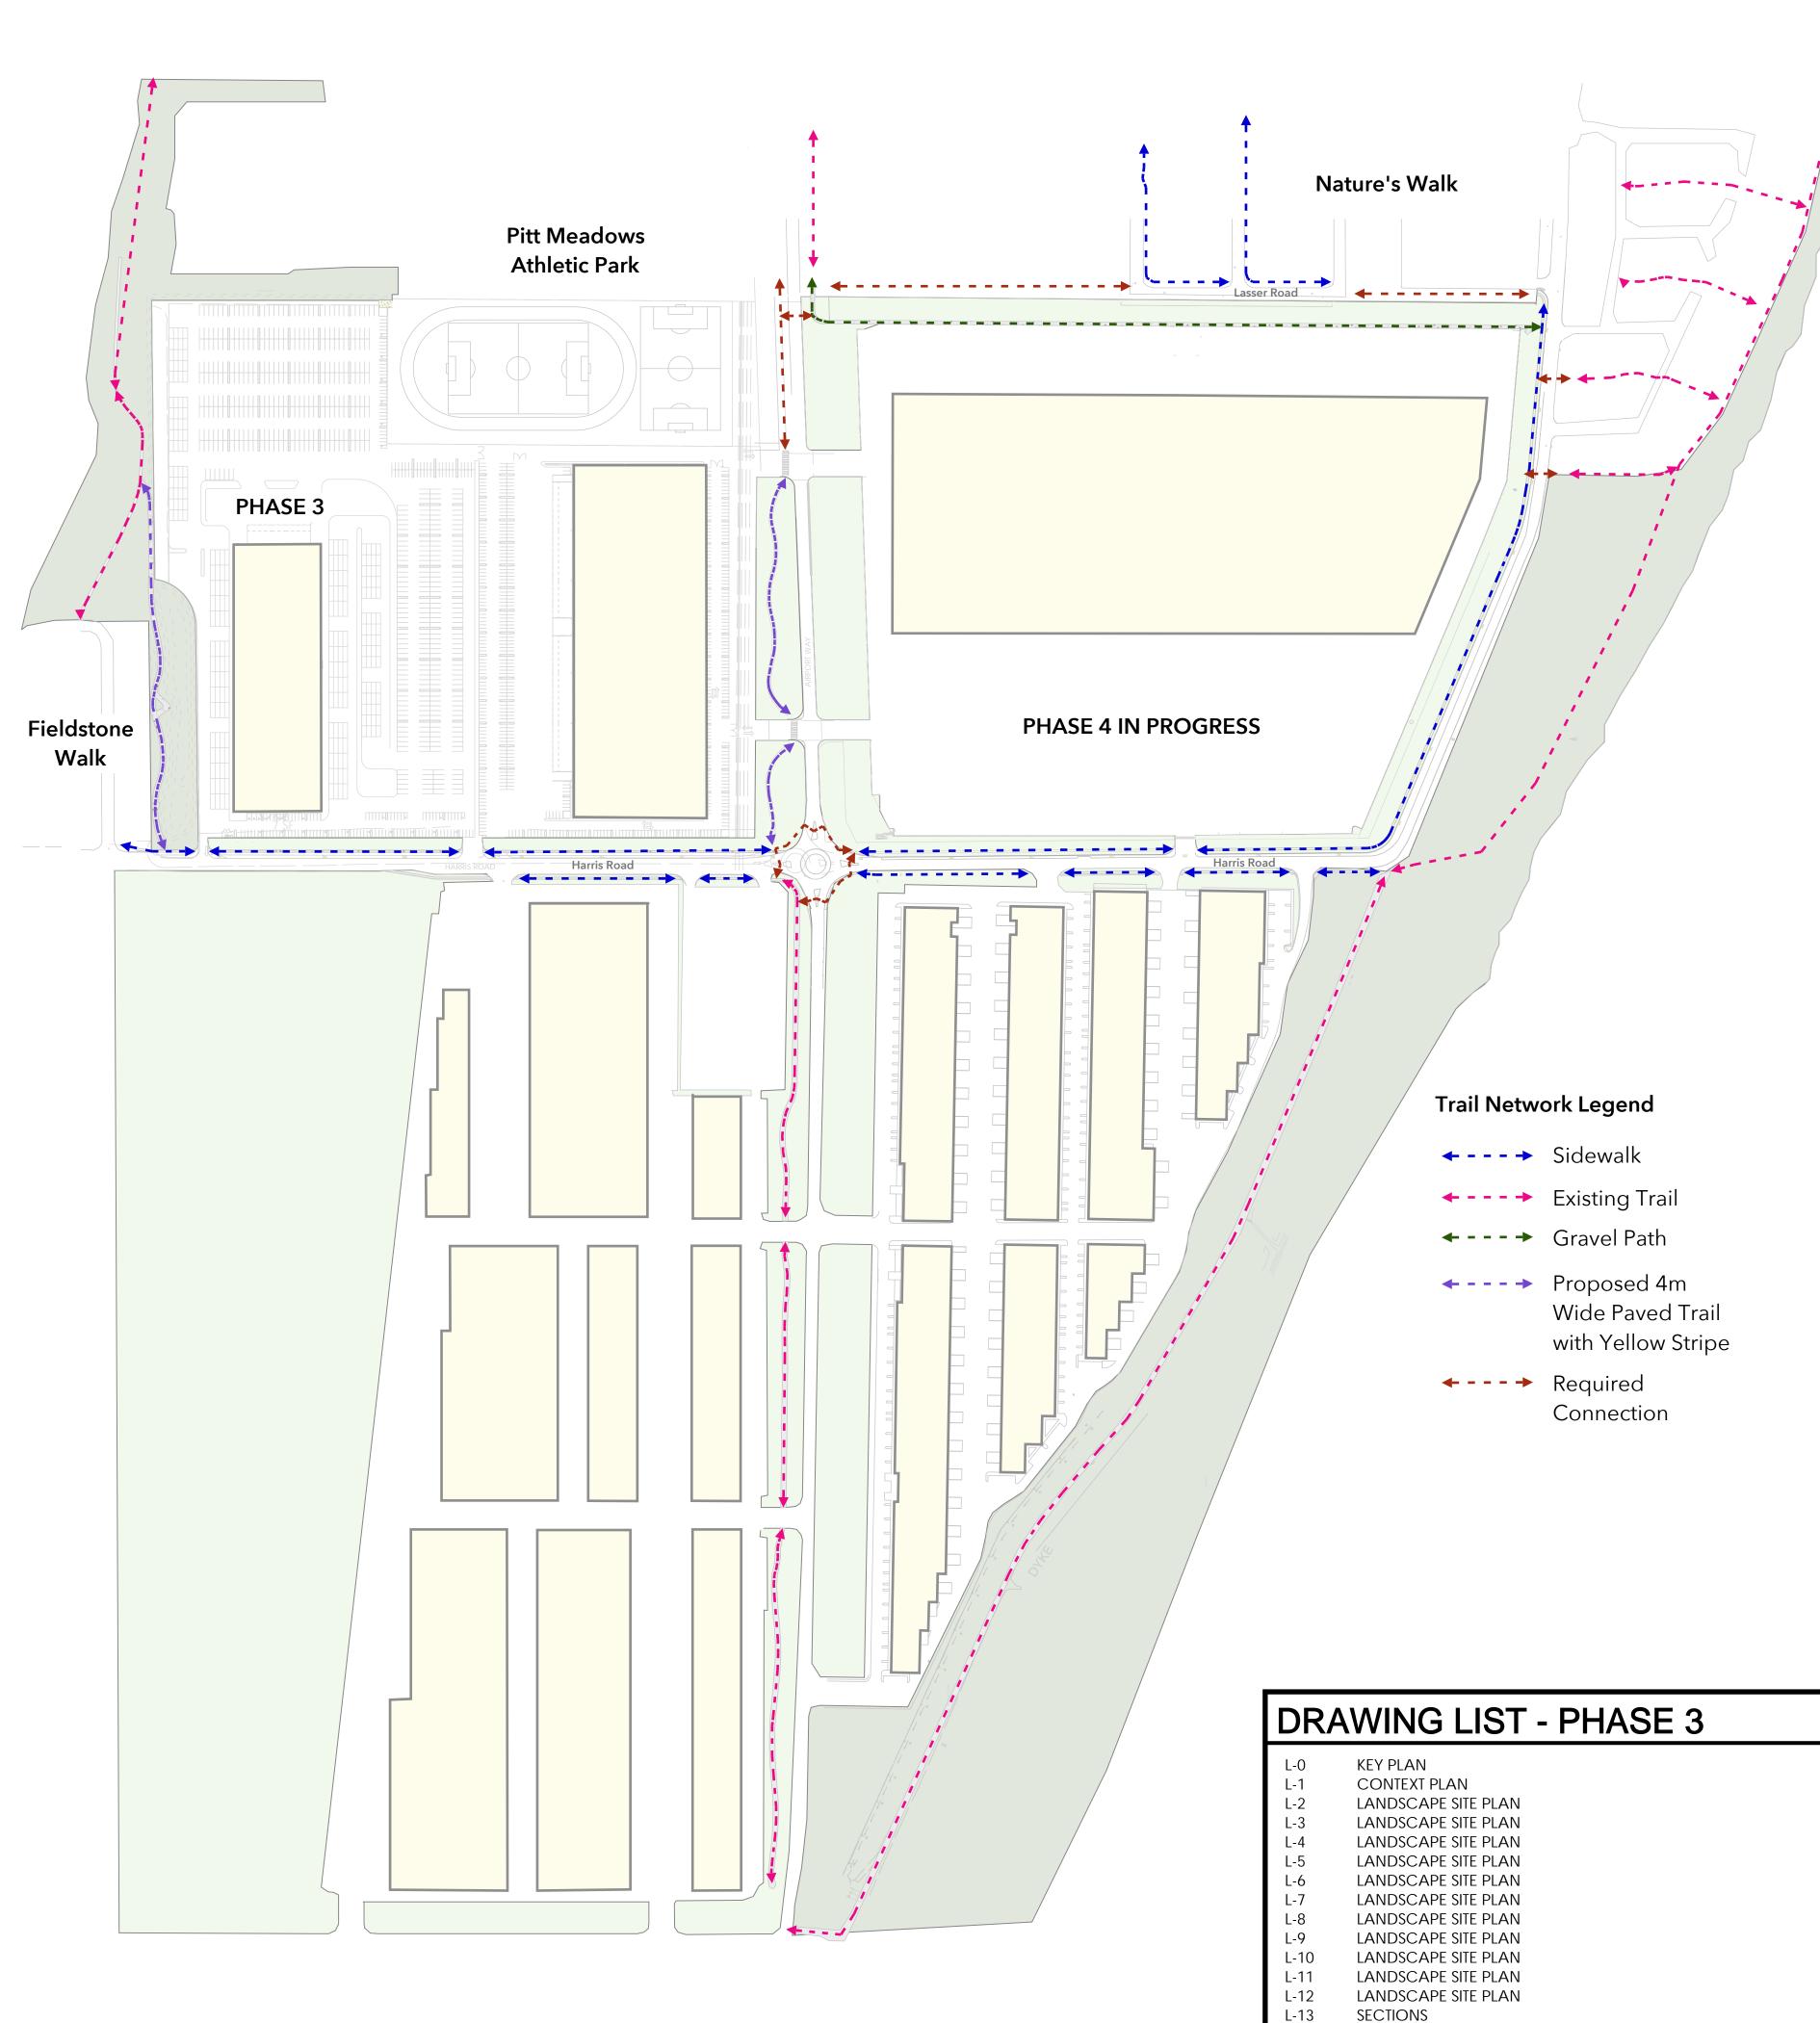

Material Legend			
Detail	Key	Material De	scription
Ld-07 L-16	P1	Asphalt path	4m Wide with Yellow Stripe Down Centre
Ld-09 L-16	P2X	Catch Basin with Pea Gravel in Bioswale	4m Wide with Yellow Stripe Down Centre
Ld-04 L-16		Hydroseed	Wildflower Mix by Premier Pacific Seed or approved equivalent
	(==,)	Berm	
Ld-04 L-16		Hydroseed	Native Grass Seed Mix by Premier Pacific Seed or approved equivalent
Ld-03 L-16		Sod Lawn (Offsite)	On 6" of Growing Medium
Ld-02 L-16		Shrubs / Planting beds	On 18" of Growing Medium
	<b>♦ F</b> -1	Bird Houses	Make and Model TBD
Ld-06 L-16	(F-2)	Landscape Boulders	Varies
Ld-05 L-16 L-16	F-3	Picnic Table	Make and Model TBD
	F-4	Bench - with back	Make and Model TBD

# On-Site Plant List

Syn	n Otv	y Botanical Name	Common Name	Size/Space
Jyn	3	Acer circinatum	Vine maple	2.5m ht (multi)
	108	Acer rubrum 'Bowhall'	Bowhall red maple	7cm cal. (col)
	5	Acer platanoides 'Princeton Gold'	Princeton Gold Norway maple	7cm (multi)
	9	Acer rubrum 'Sun Valley'	Sun Valley red maple	7cm cal. B+B
vy.	11	Acer macrophyllum	Big Leaf maple	8cm cal. B+B
A STAN	8	Acer truncatum	Shantung maple	7cm cal. B+B
	130	Quercus palustris 'Green Pillar'	Green Pillar pin oak	7cm cal. B+B
N W	<del>-</del> 54	Populus trembling 'Prarie Gold'	Prarie Gold trembling aspen	5cm cal. B+B
× +	<u>₹</u> - 52	Pseddotsuga menzeisii	Douglas fir	3m ht B+B
and the second	<u>m</u> 30	Picea sitchensis	Sitka spruce	2m ht B+B
	3	Picea omorika	Serbian Spruce	3m Ht B+B
	10	Styrax japonicus	Japanese Snowbell	5cm cal. B+B
Winn Mark	17 mg	Thuja pilcata	Western red cedar	2m ht B+B
A Anna	42	Tsuga heterophyla	Western hemlock	2.5m ht B+B
Sym	/Oty	Botanical Name	Common Name Size/Spa	ace/Comments
	3,086 3,181	Shrubs Arctostaphylos-uva-ursi Ceanothus velutinus	Kinnikinnick, bearberry Snowbush	4" pot/1'-0" o.c. #2 pot/30" o.c.
	3,468	Cornus sericea 'Kelseyi'	Dward red-osier dogwood	#2 pot/30" o.c.
	940 689	Oemleria cerasiformis Rosa nutkana	Indian Plum Nootka rose	#2 pot/36" o.c. #2 pot/3'-0" o.c.
	1,928	YVaocinium ovatum YYYYYY	**************************************	#2 pot/3'-0" v.c.
<b>©</b>	757	Calluna vulgaris	scotch heather	#2 pot/30" o.c.
h	818	Hebe pinguifolia "Sutherlandi"	Sutherland-Hebe	x#2patx36"ac/
Jw	1364	Juniperus horizontallis 'Wiltoni'	Blue Rug Creeping juniper	#2 pot/3'-0" o.c.
(V)	686	Lavandula angustifolia "Hidcote"	Lavender	#2 pot/30" o.c.
	1482 399	Lonicera pileata Mahonia repens	Box-leaved honeysuckle Creeping Oregon grape	#2 pot/30" o.c. #2 pot/36" o.c.
	76	Rosa meidiland "White"	meidiland rose	#3 pot/4'-0" o.c.
(R)	51	Rosa "Simon Fraser"	Simon Fraser rose	#3 pot/4'-0" o.c.
$\mathbb{V}$	1687	Viburnum davidii	David's viburnum	#2 pot/2'-0" o.c.
		BioSwale		. = 1 = 0 0.0.
	3552	Carex obnupta *In Lower Zone	e* Slough Sedge	4" pot/1'-0" o.c.
	444	Iris douglasiana *In Lower Zone	9	4" pot/2'-0" o.c.
	197	Salix purpurea 'nana' *In Upper Zone	e* Nana Purple Willow	4" pot/3'-0" o.c.

# General Notes

SECTIONS


SECTIONS

DETAILS

L-15

L-16

- 1. All plants / planting to be per BCNTA and BCSLA standards.
- Plant selection subject to availability at the time of planting.
- Contractor shall source specified plant material and only after area of search has been exhausted will substitutions be considered.
- 4. All trees to be staked in accordance with BCNTA Standards. 5. All plants to be sourced from nurseries certified free of P. ramorum.
- 6. Plant sizes and related container classes are specified according to the B.C. Landscape Standards current edition. For container classes #3 and smaller, plant sizes shall be as shown in the plant list and the standard; for all other plants, both plant size and container calls shall be as shown in the plant list. Specifically, when the plant list calls for #5 class containers, these shall be as defined in the BCNTA (ANSI) Standard.
- 7. All offsite trees to have minimum 15 cubic meters of growing medium unless otherwise specified.
- Soil Preparation and Placement Notes
- All growing medium placed on project to meet or exceed BCNTA and B.C Landscape Standards latest edition.
   Submit sieve analysis by an approved independent soil testing laboratory for each type of growing medium being used on the project
- PRIOR to placement for review and approval. Clearly identify source and type for each. Resubmit as required until growing medium is approved. Provide one composite sample of each type of proposed growing medium for each different application within the project. Minimum 1 litre physical sample.
- 3. Submittals shall be made at least seven (7) days prior placement.
- 4. Contractor shall not move or work growing medium or additives when they are excessively wet, extremely dry, or frozen or in any manner which will adversely affect growing medium structure. Growing medium whose structure has been destroyed by handling under these conditions will be rejected. Growing medium shall not be handled in wet or frozen conditions.
- Irrigation Notes (Design-Build System)
- 1. Irrigation to be provided for all 'Soft Landscape Areas' (unless otherwise specified) shown on the drawing. 2. All 'Soft Landscape Areas' are to be irrigated with high efficiency design build irrigation system to IIABC Standards, c/w rain sensor unless
- otherwise specified. 3. All irrigation valve boxes equipped with quick-couplers.
- 4. Layout of the system and installation shall be to trade standards for projects of this scale and type, to provide for uniform complete "head to head" coverage of all lawn and planted areas within the area as designated on the drawings.
- 5. Record Drawings: Submit with the operating and maintenance manuals, a reproducible copy of the as-built condition of the system. 6. Instruct a designated representative of the Owner in the complete operating and maintenance procedures for that system, including winterizing the system for the first time with the designated representative observing.
- NOTE: Sleeving @ roadways to use schedule 40 cast iron sleeving. Quality Assurance
- 1. The irrigation system design and installation shall be in accordance with the Irrigation Industry of BC Standards and Guidelines. 2.All irrigation work shall be done by an experienced and competent irrigation contractor having the facilities and personnel adequate for the work specified. Minimum standard to IIABC.

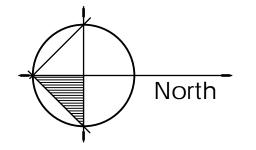

04 Dec 19, 2019 Re-Issue for DP 03 Oct 30, 2019 Re-Issue for DP 02 May 01, 2019 Issue for DP 01 Mar 25, 2019 Issue for Client Review

Revisions:



Golden Ears Industrial Park Phase 3 Pitt Meadows, BC

Drawn by: Checked by: PK Apr 30, 2019 Scale:


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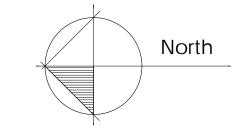
KEY PLAN

Project No.: 18088

Sheet No.:

L-O



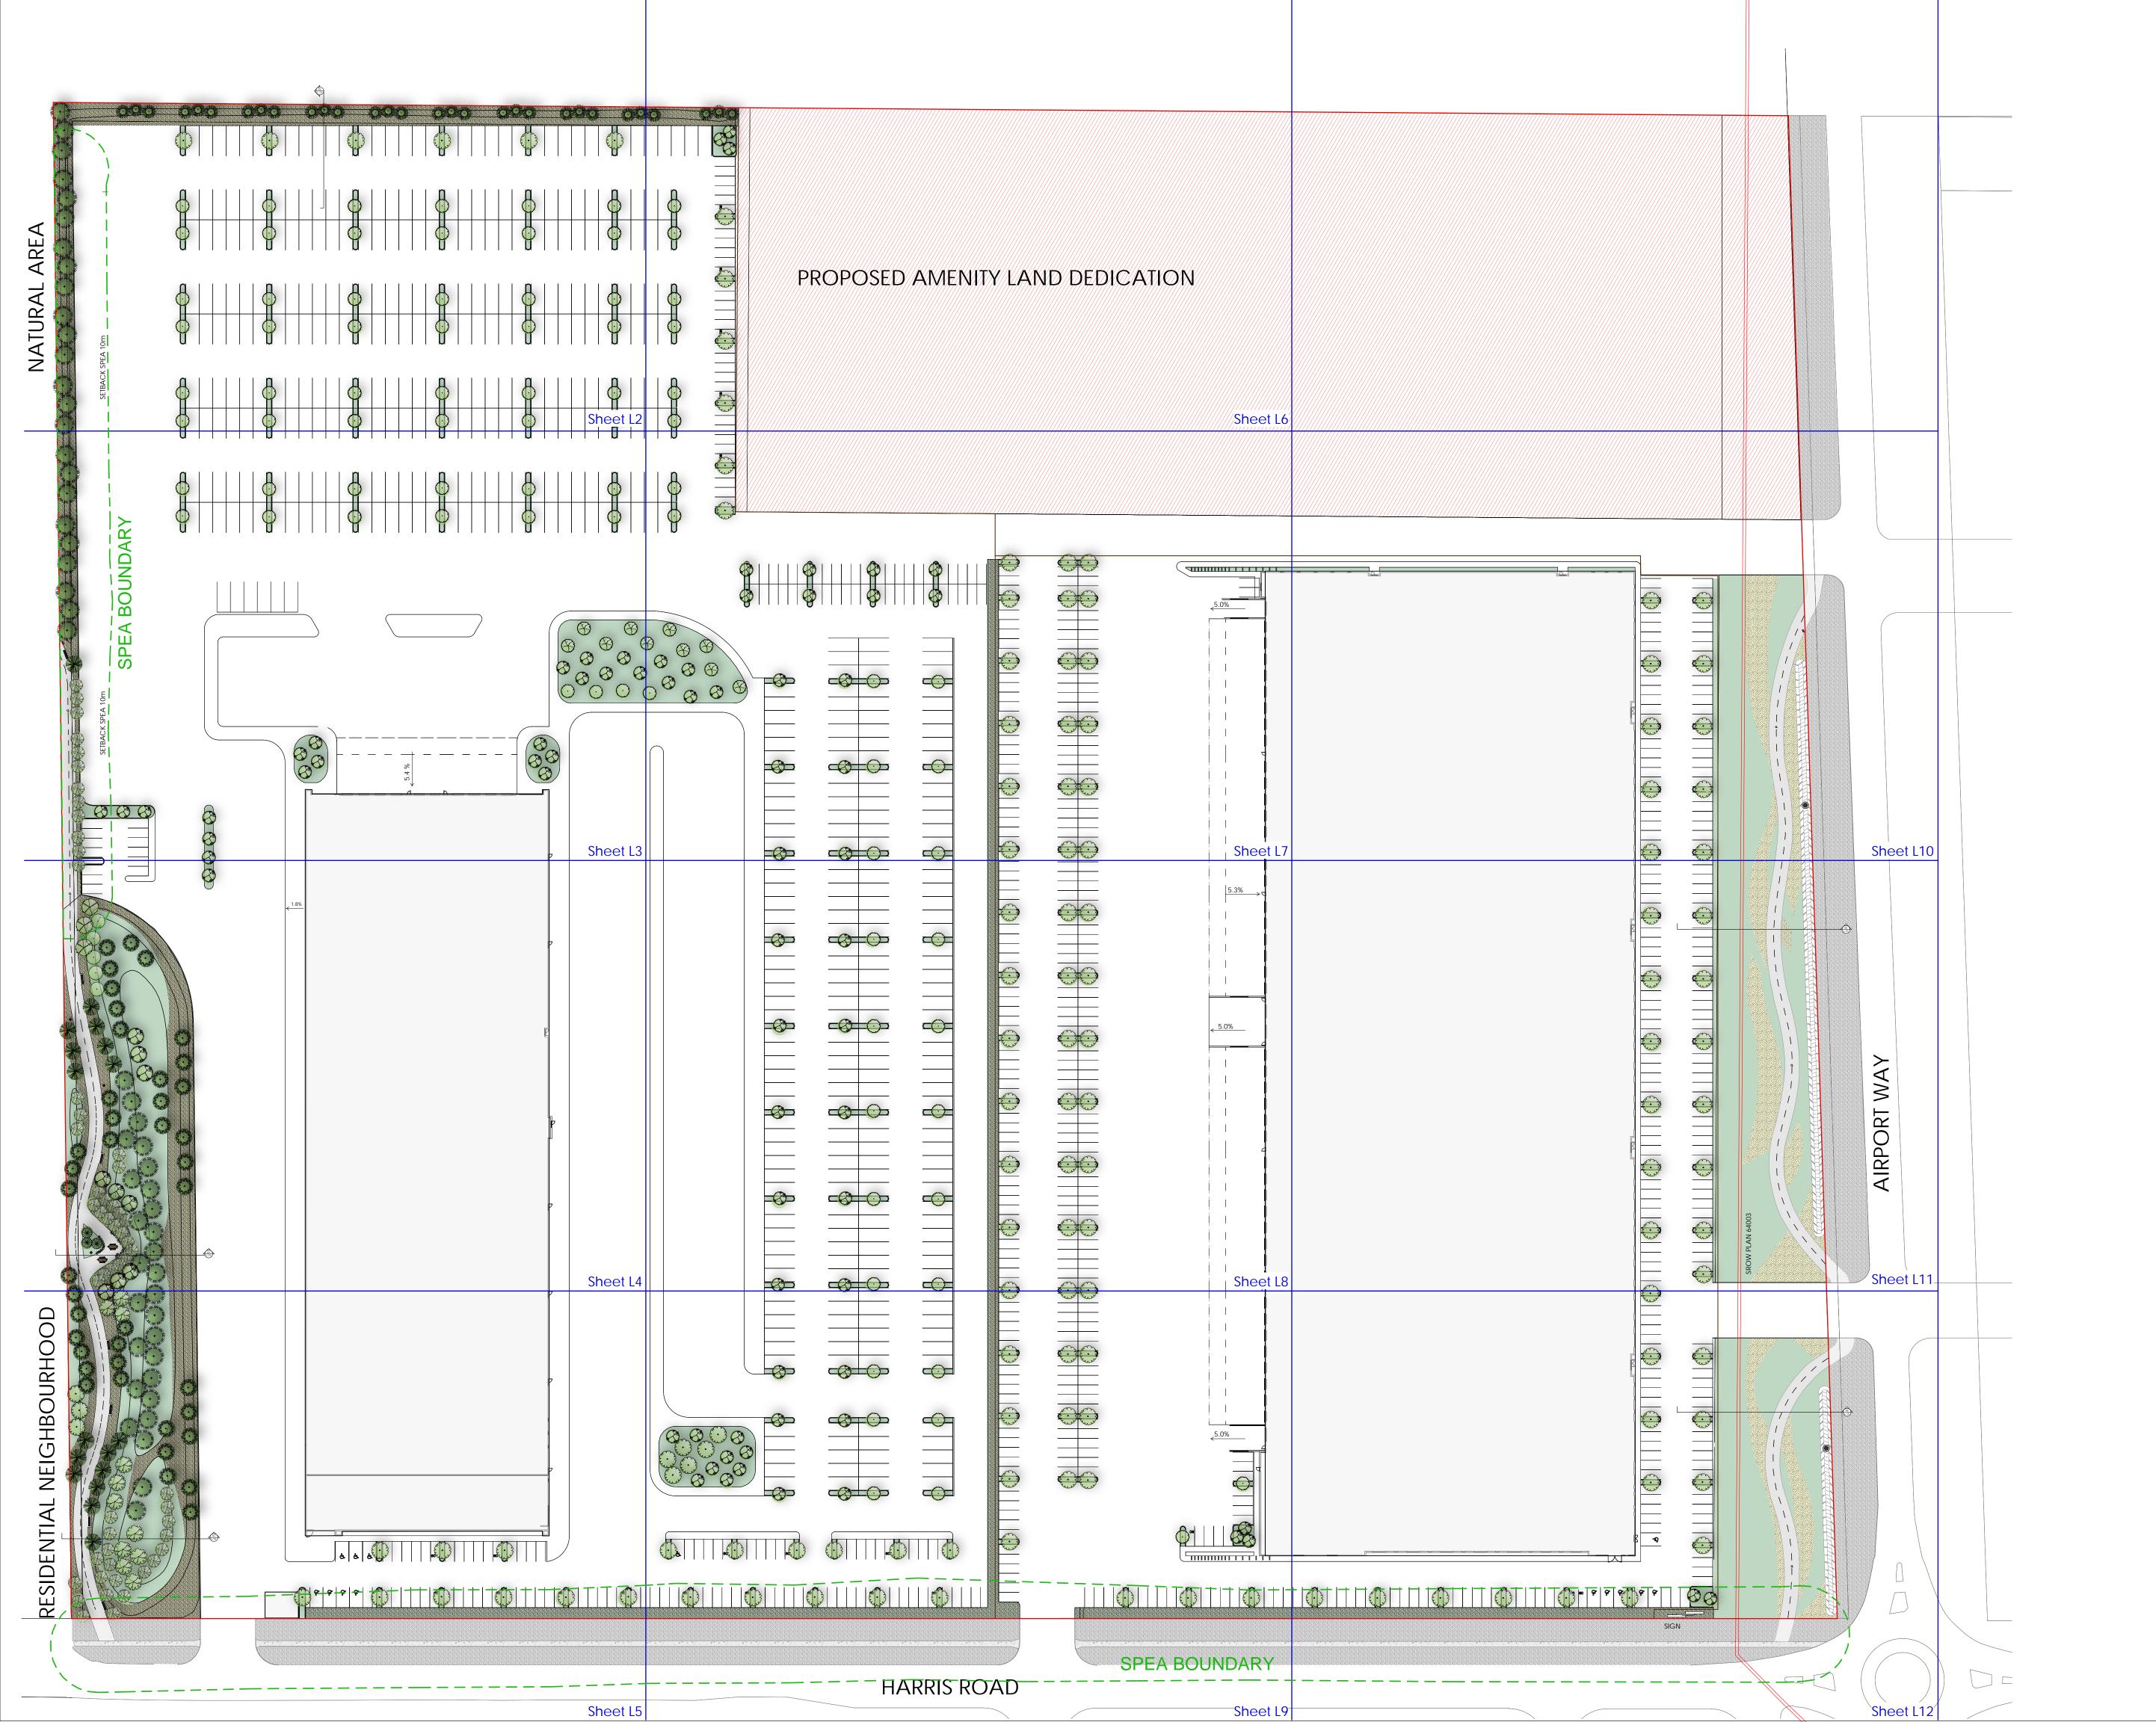

04 Dec19, 2019 Re-Issue for DP 03 Oct 30, 2019 Re-Issue for DP 02 May 01, 2019 Issue for DP 01 Mar 25, 2019 Issue for Client review



Golden Ears Industrial Park Phase 3

Pitt Meadows, BC

Drawn by:	TB/AB
Checked by:	PK
Date:	Apr 30, 2019
Scale:	NTS

Drawing Title:

CONTEXT PLAN

Project No.: 18088 Sheet No.:


# NATURAL AREA










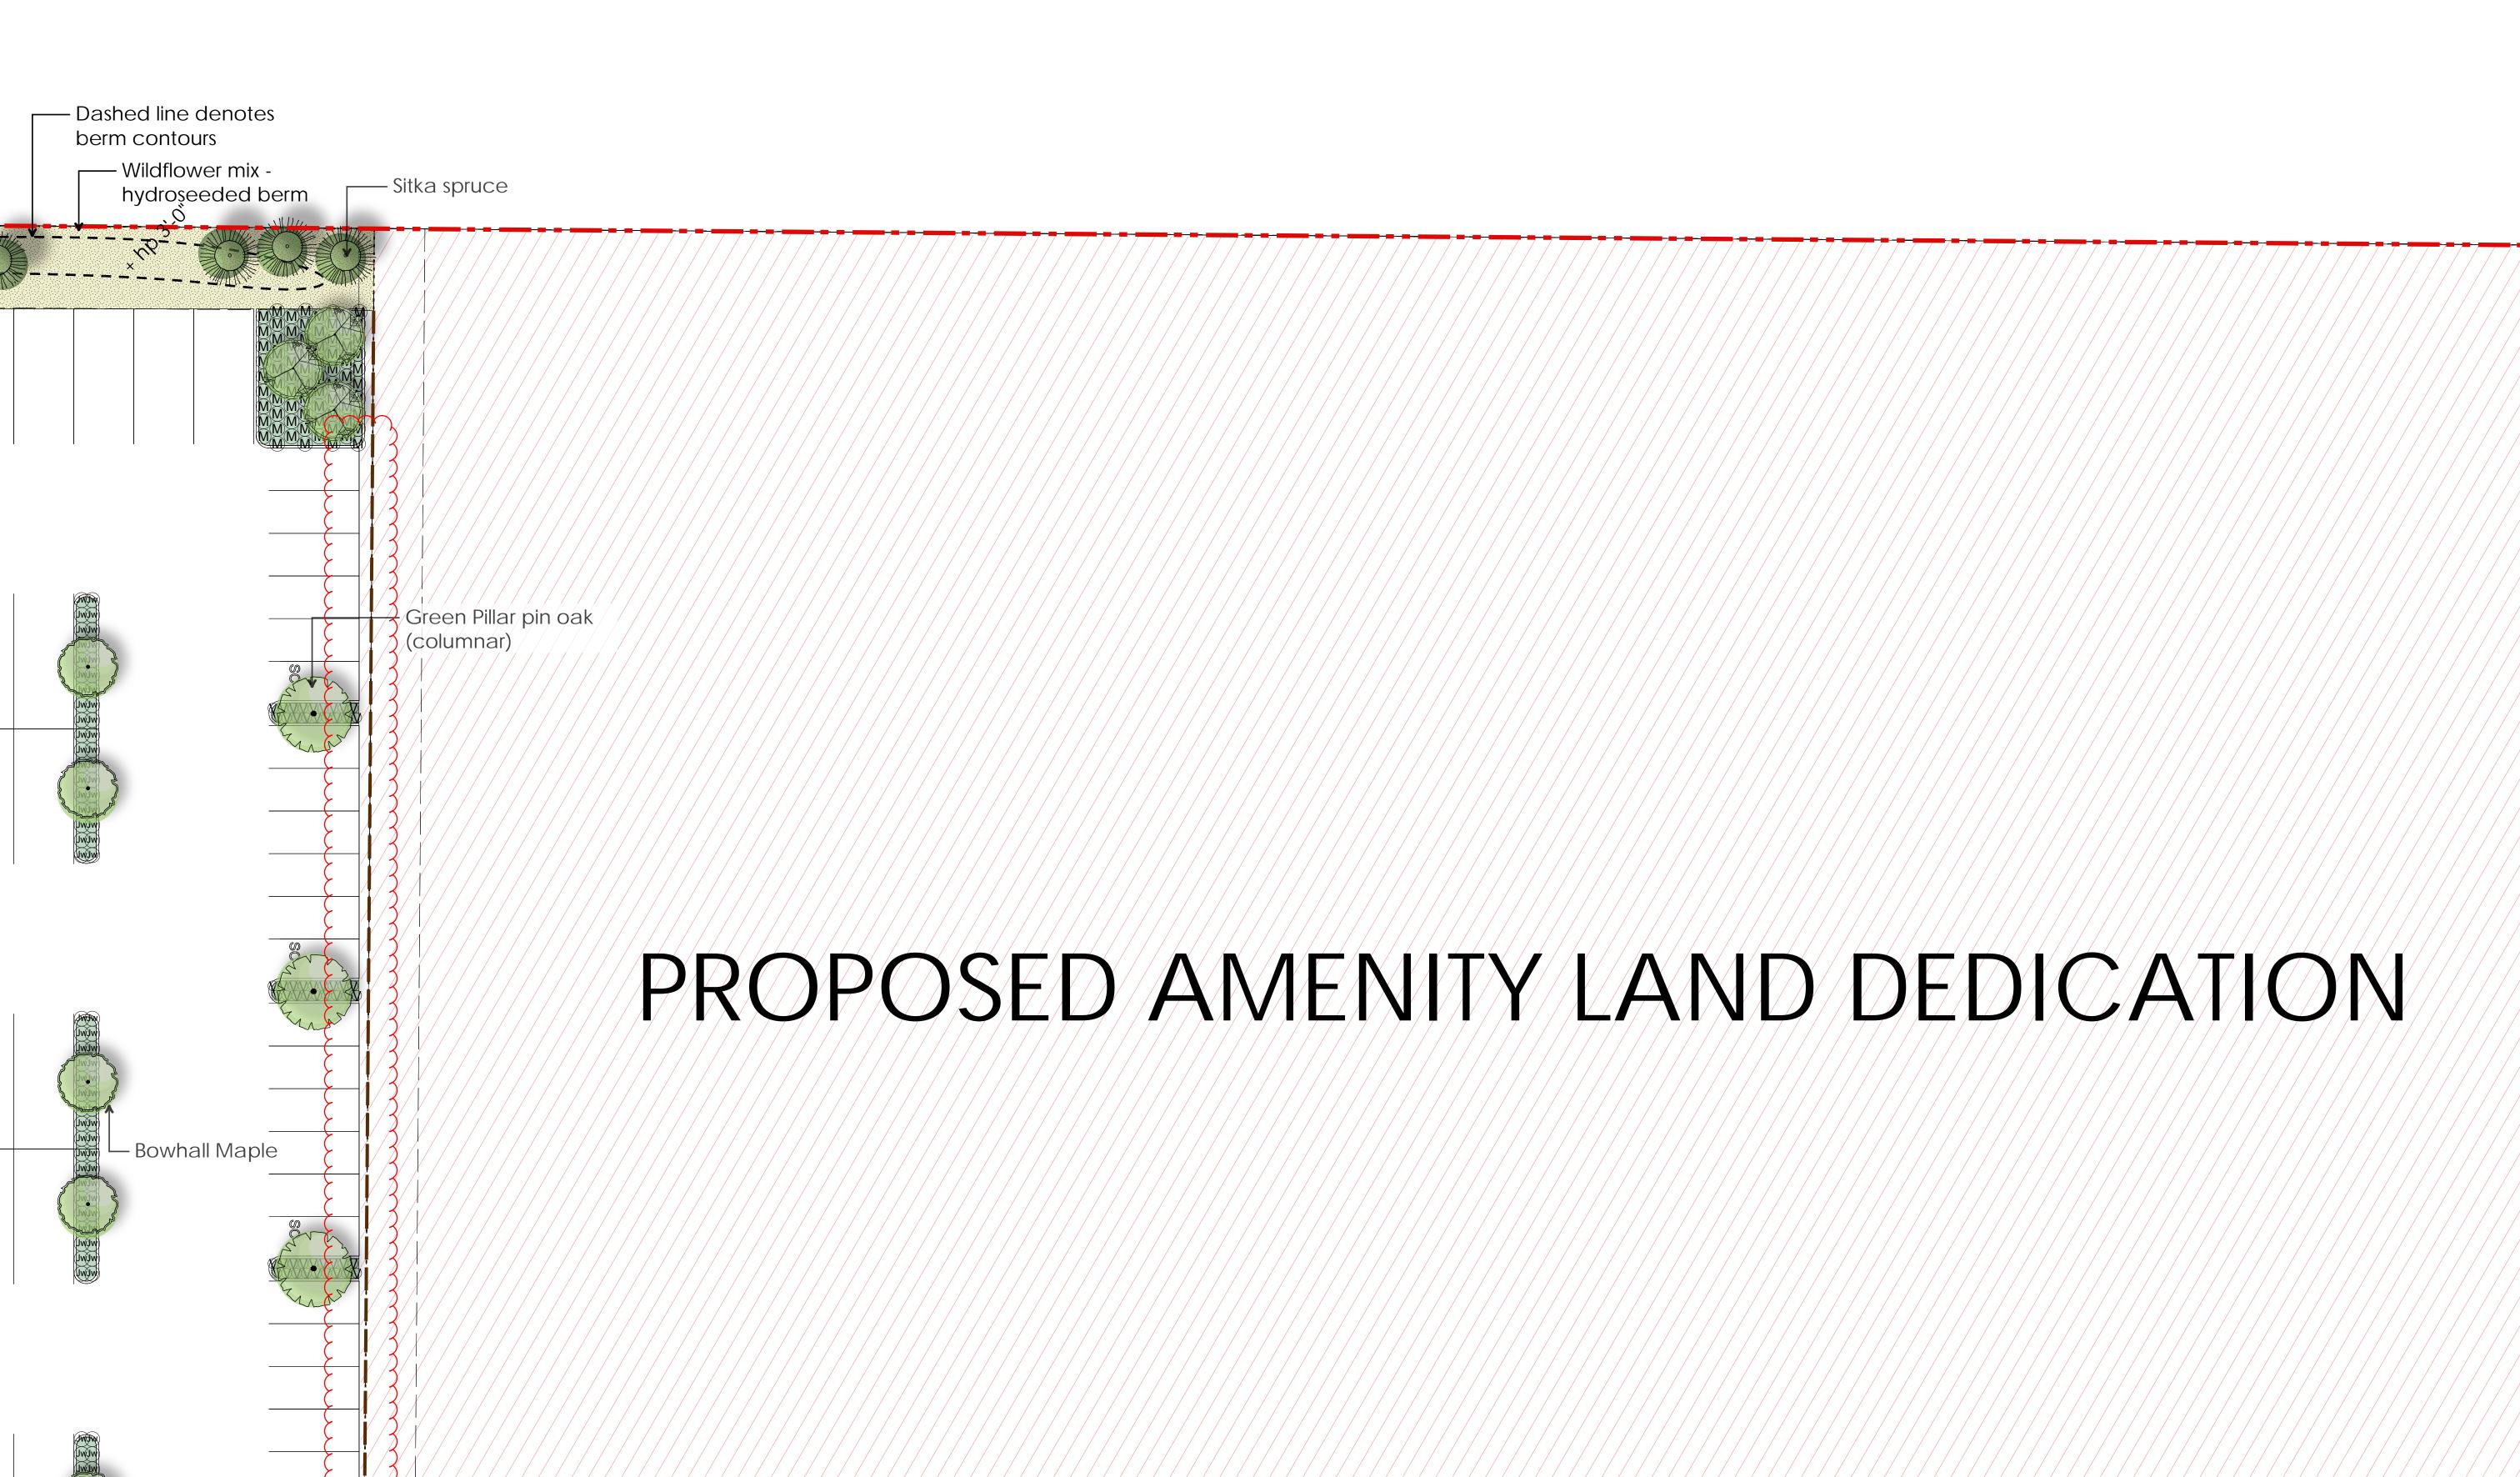

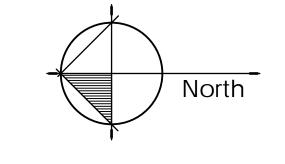

04 Dec 19, 2019 Re-Issue for DP 03 Oct 30, 2019 Re-Issue for DP 02 May 01, 2019 Issue for DP 01 Mar 25, 2019 Issue for Client Review

Revisions:

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Golden Ears Industrial Park Phase 3

Pitt Meadows, BC

Checked by:


Apr 30, 2019

1/16" = 1'-0"


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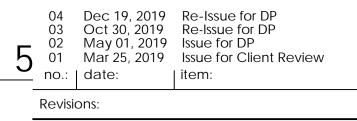
LANDSCAPE SITE PLAN

Project No.:



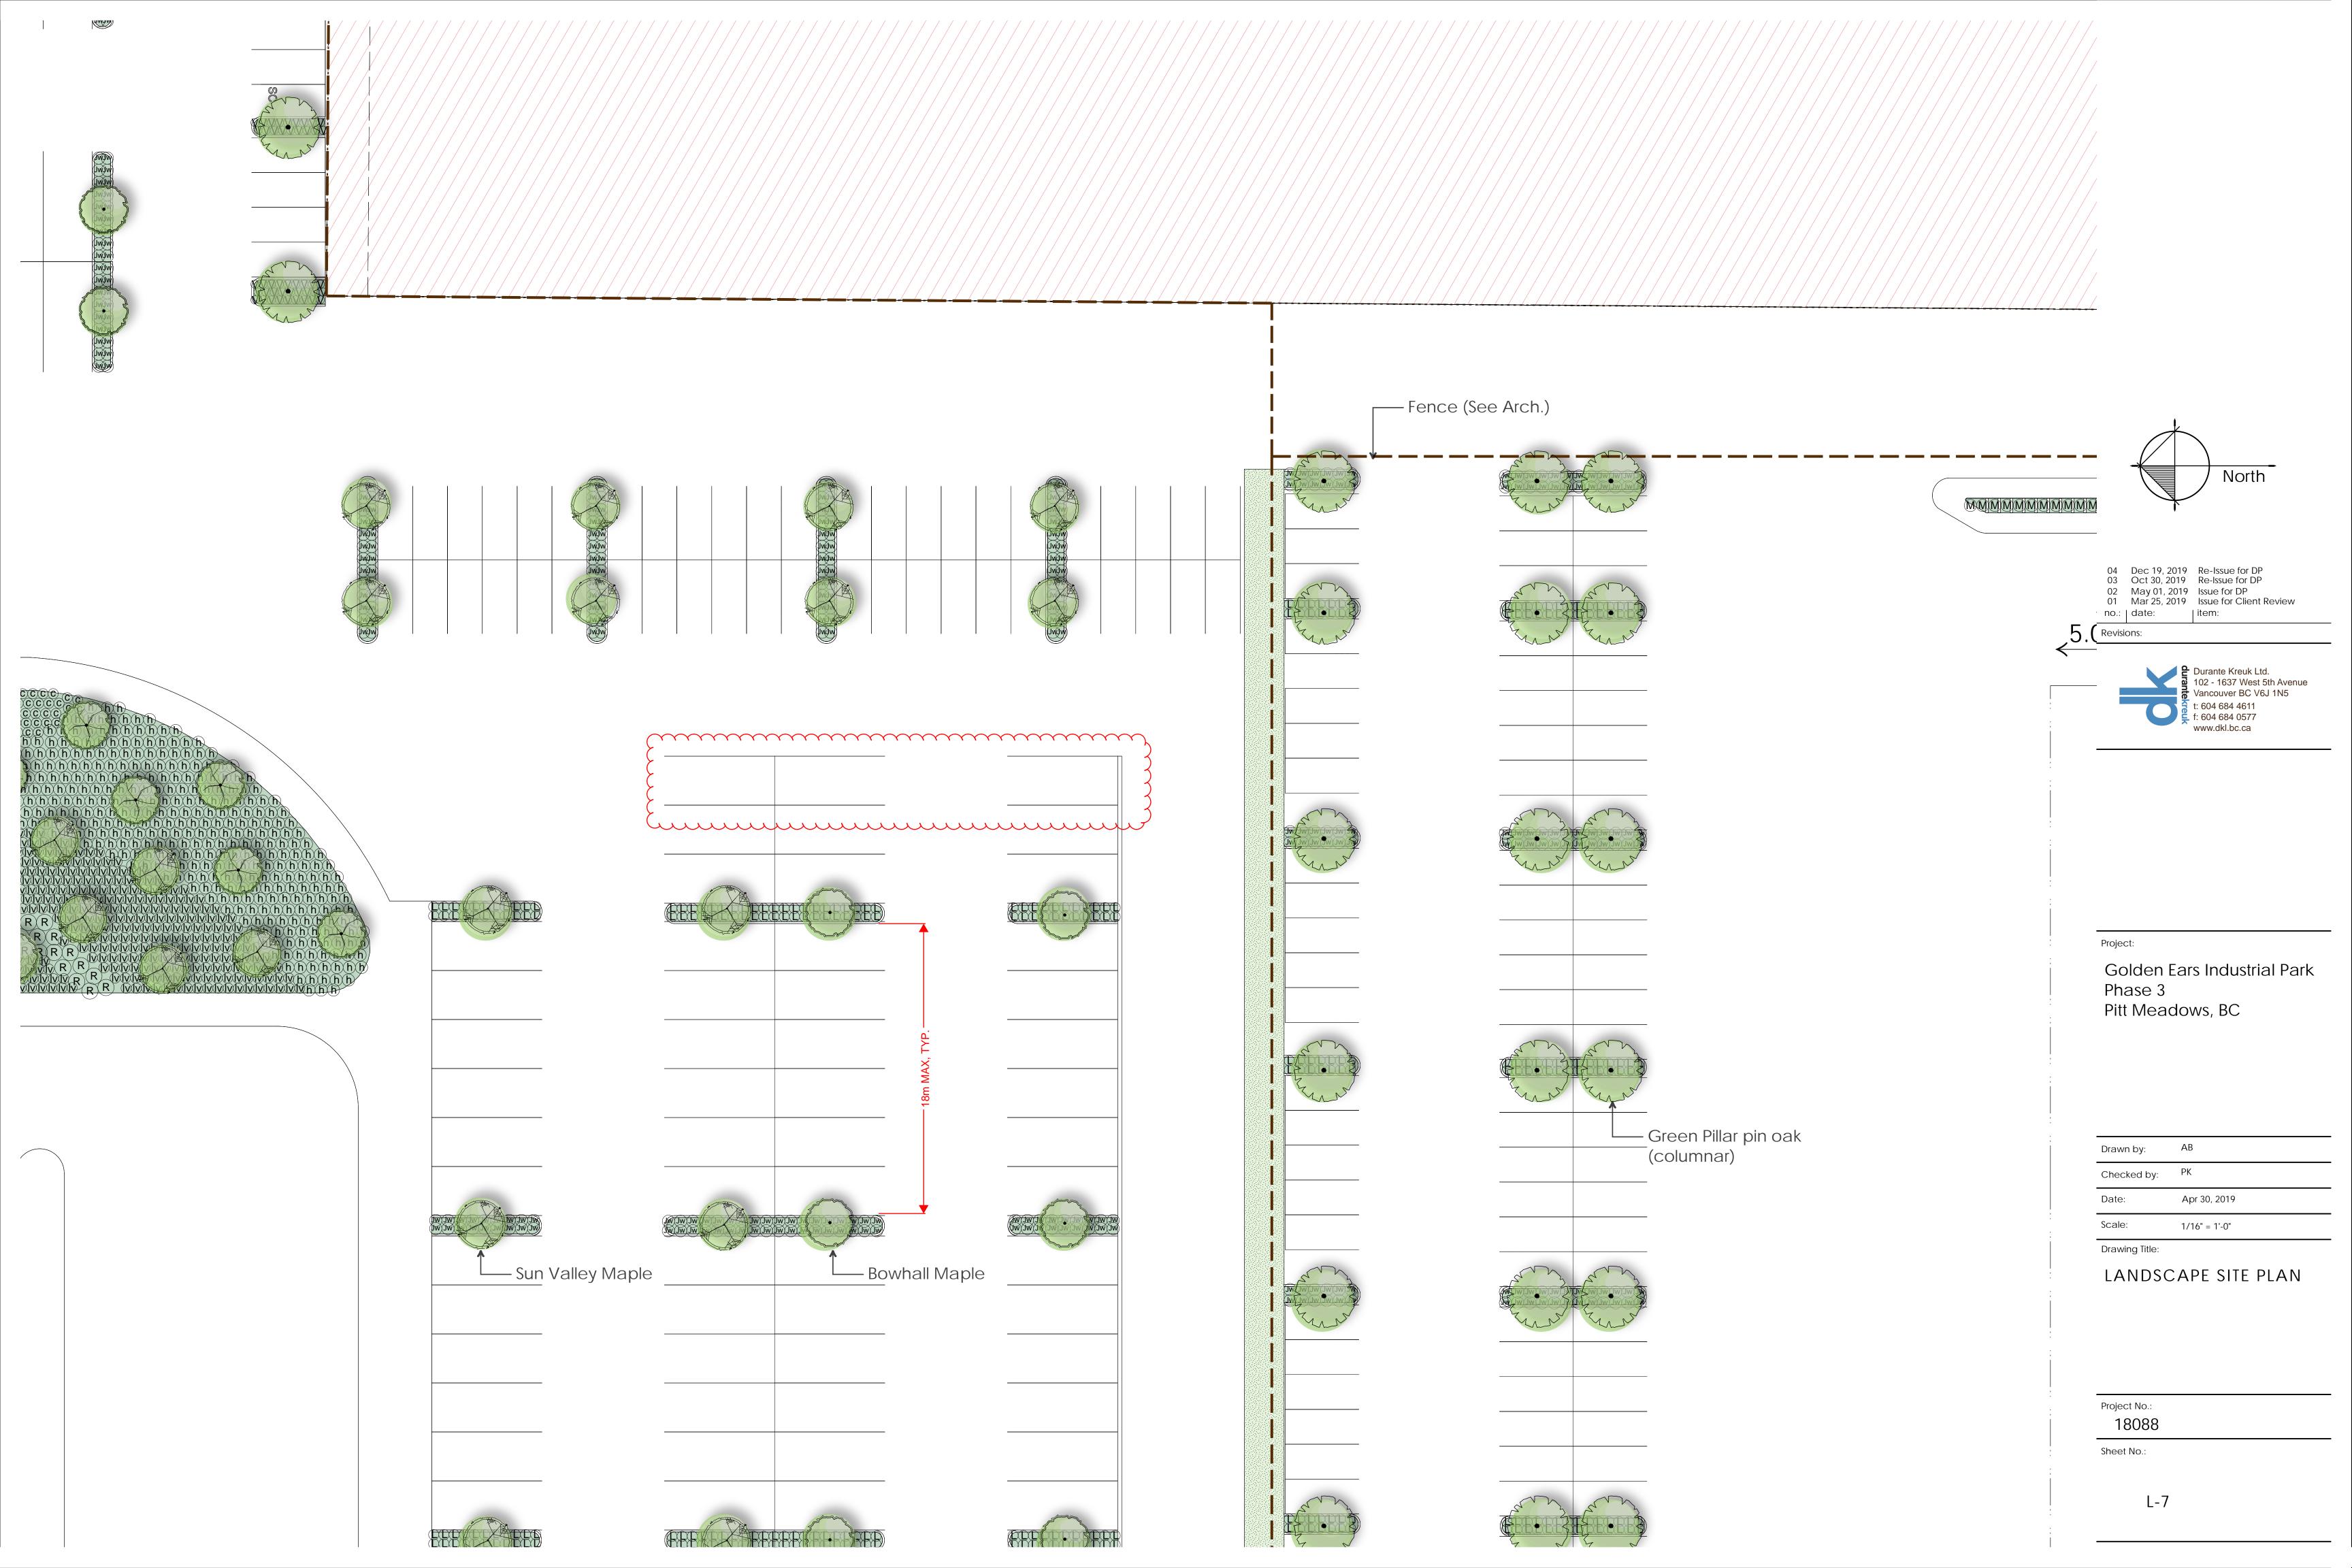




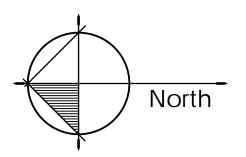






Golden Ears Industrial Park


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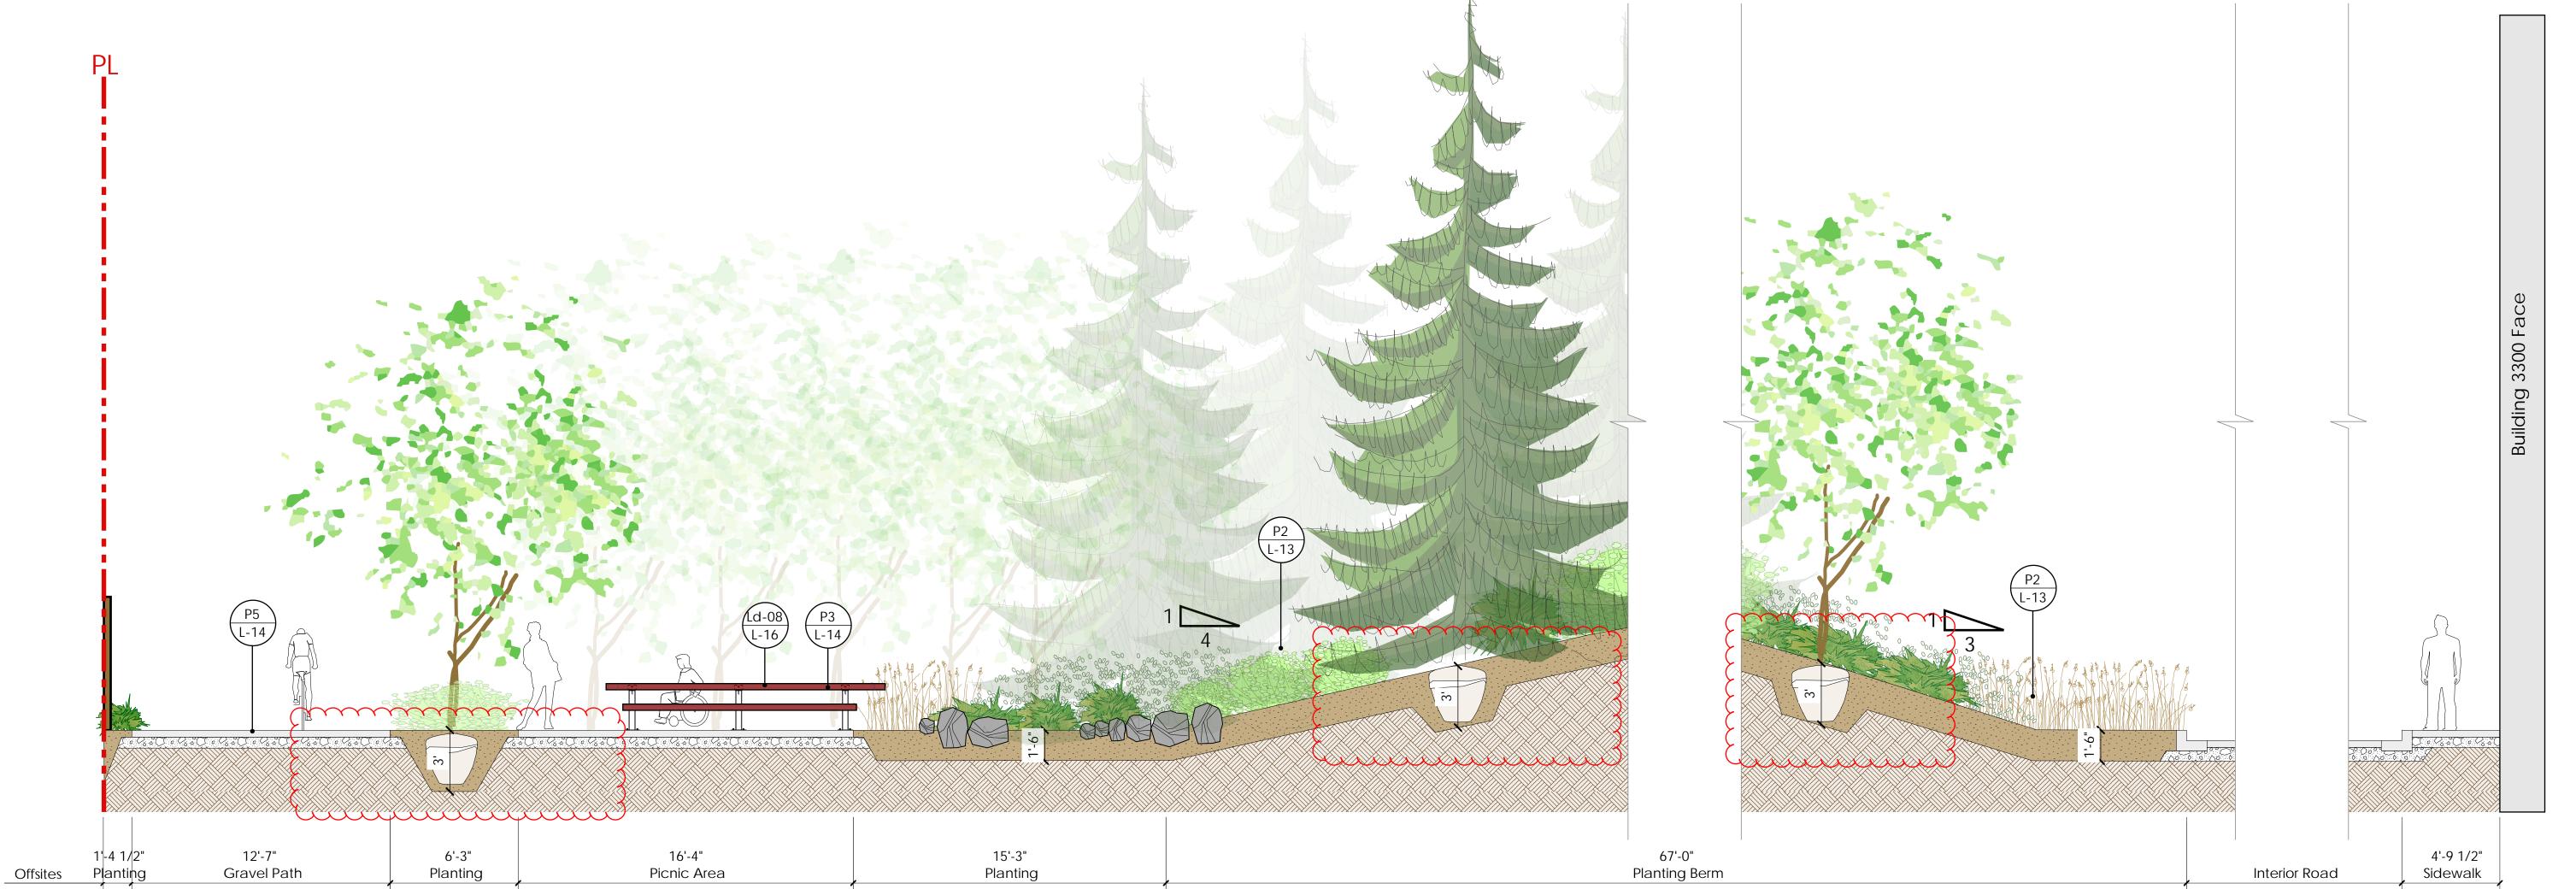


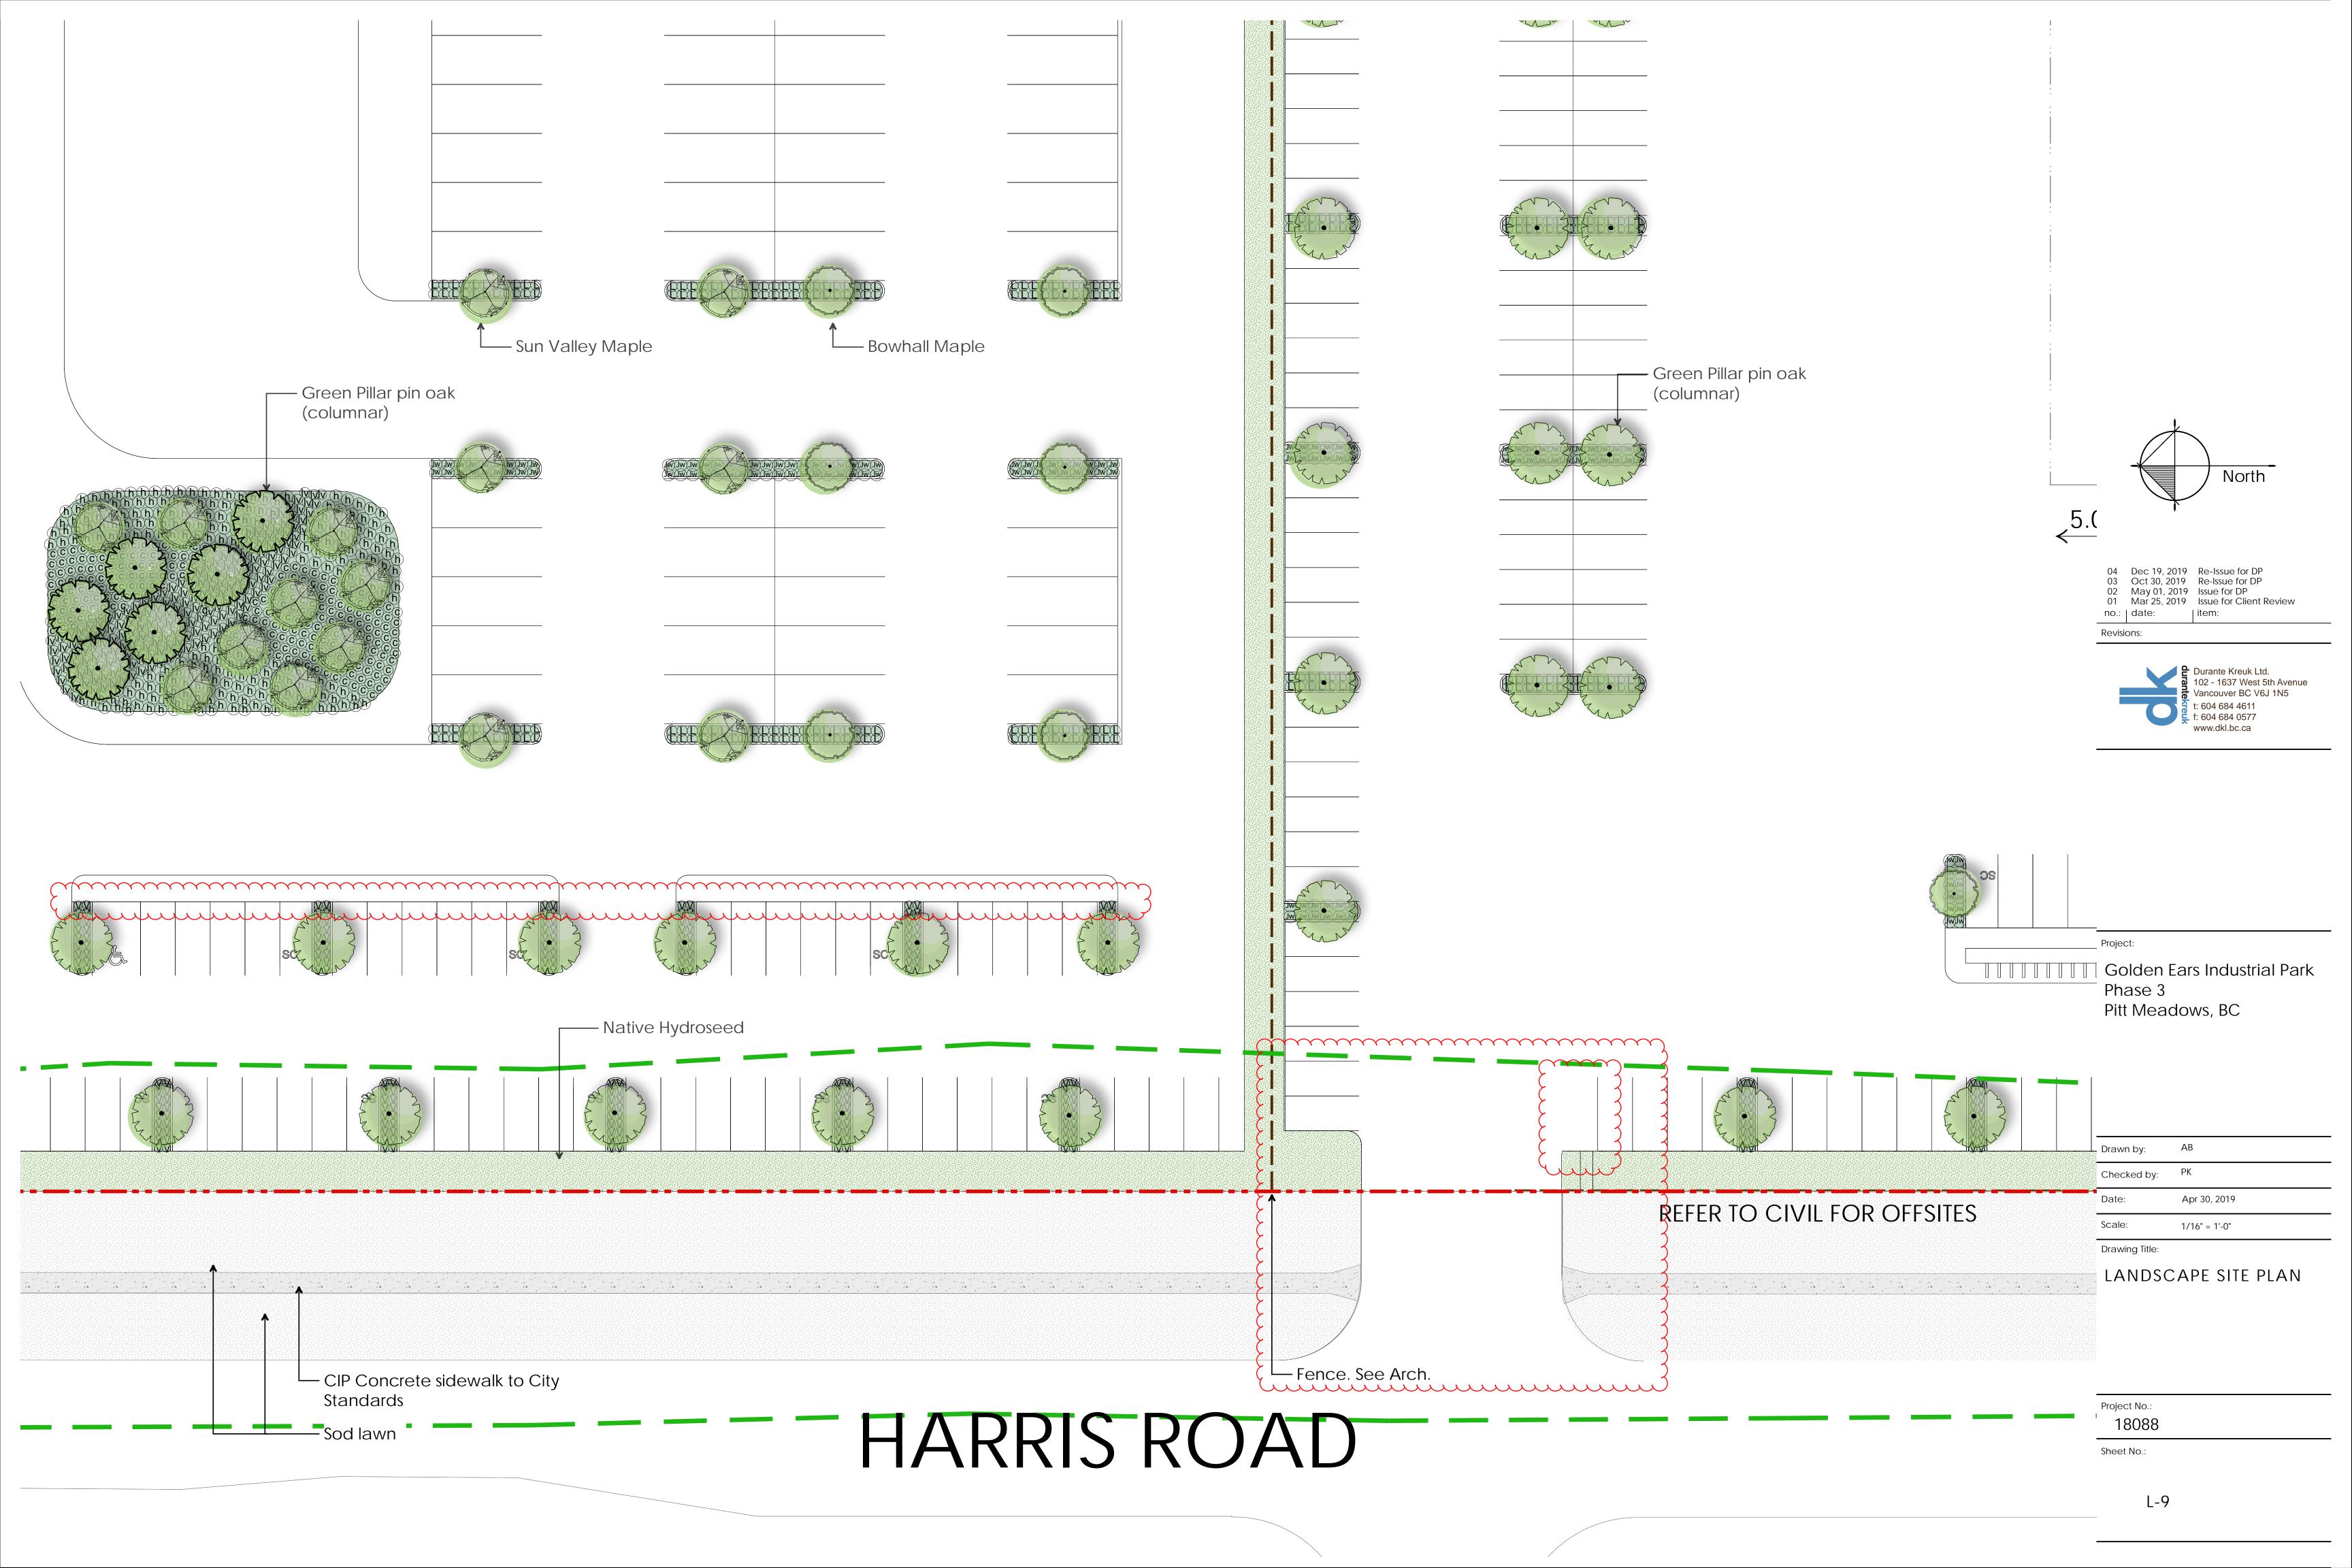P1 Precedent Image: Grove of Trembling Aspen

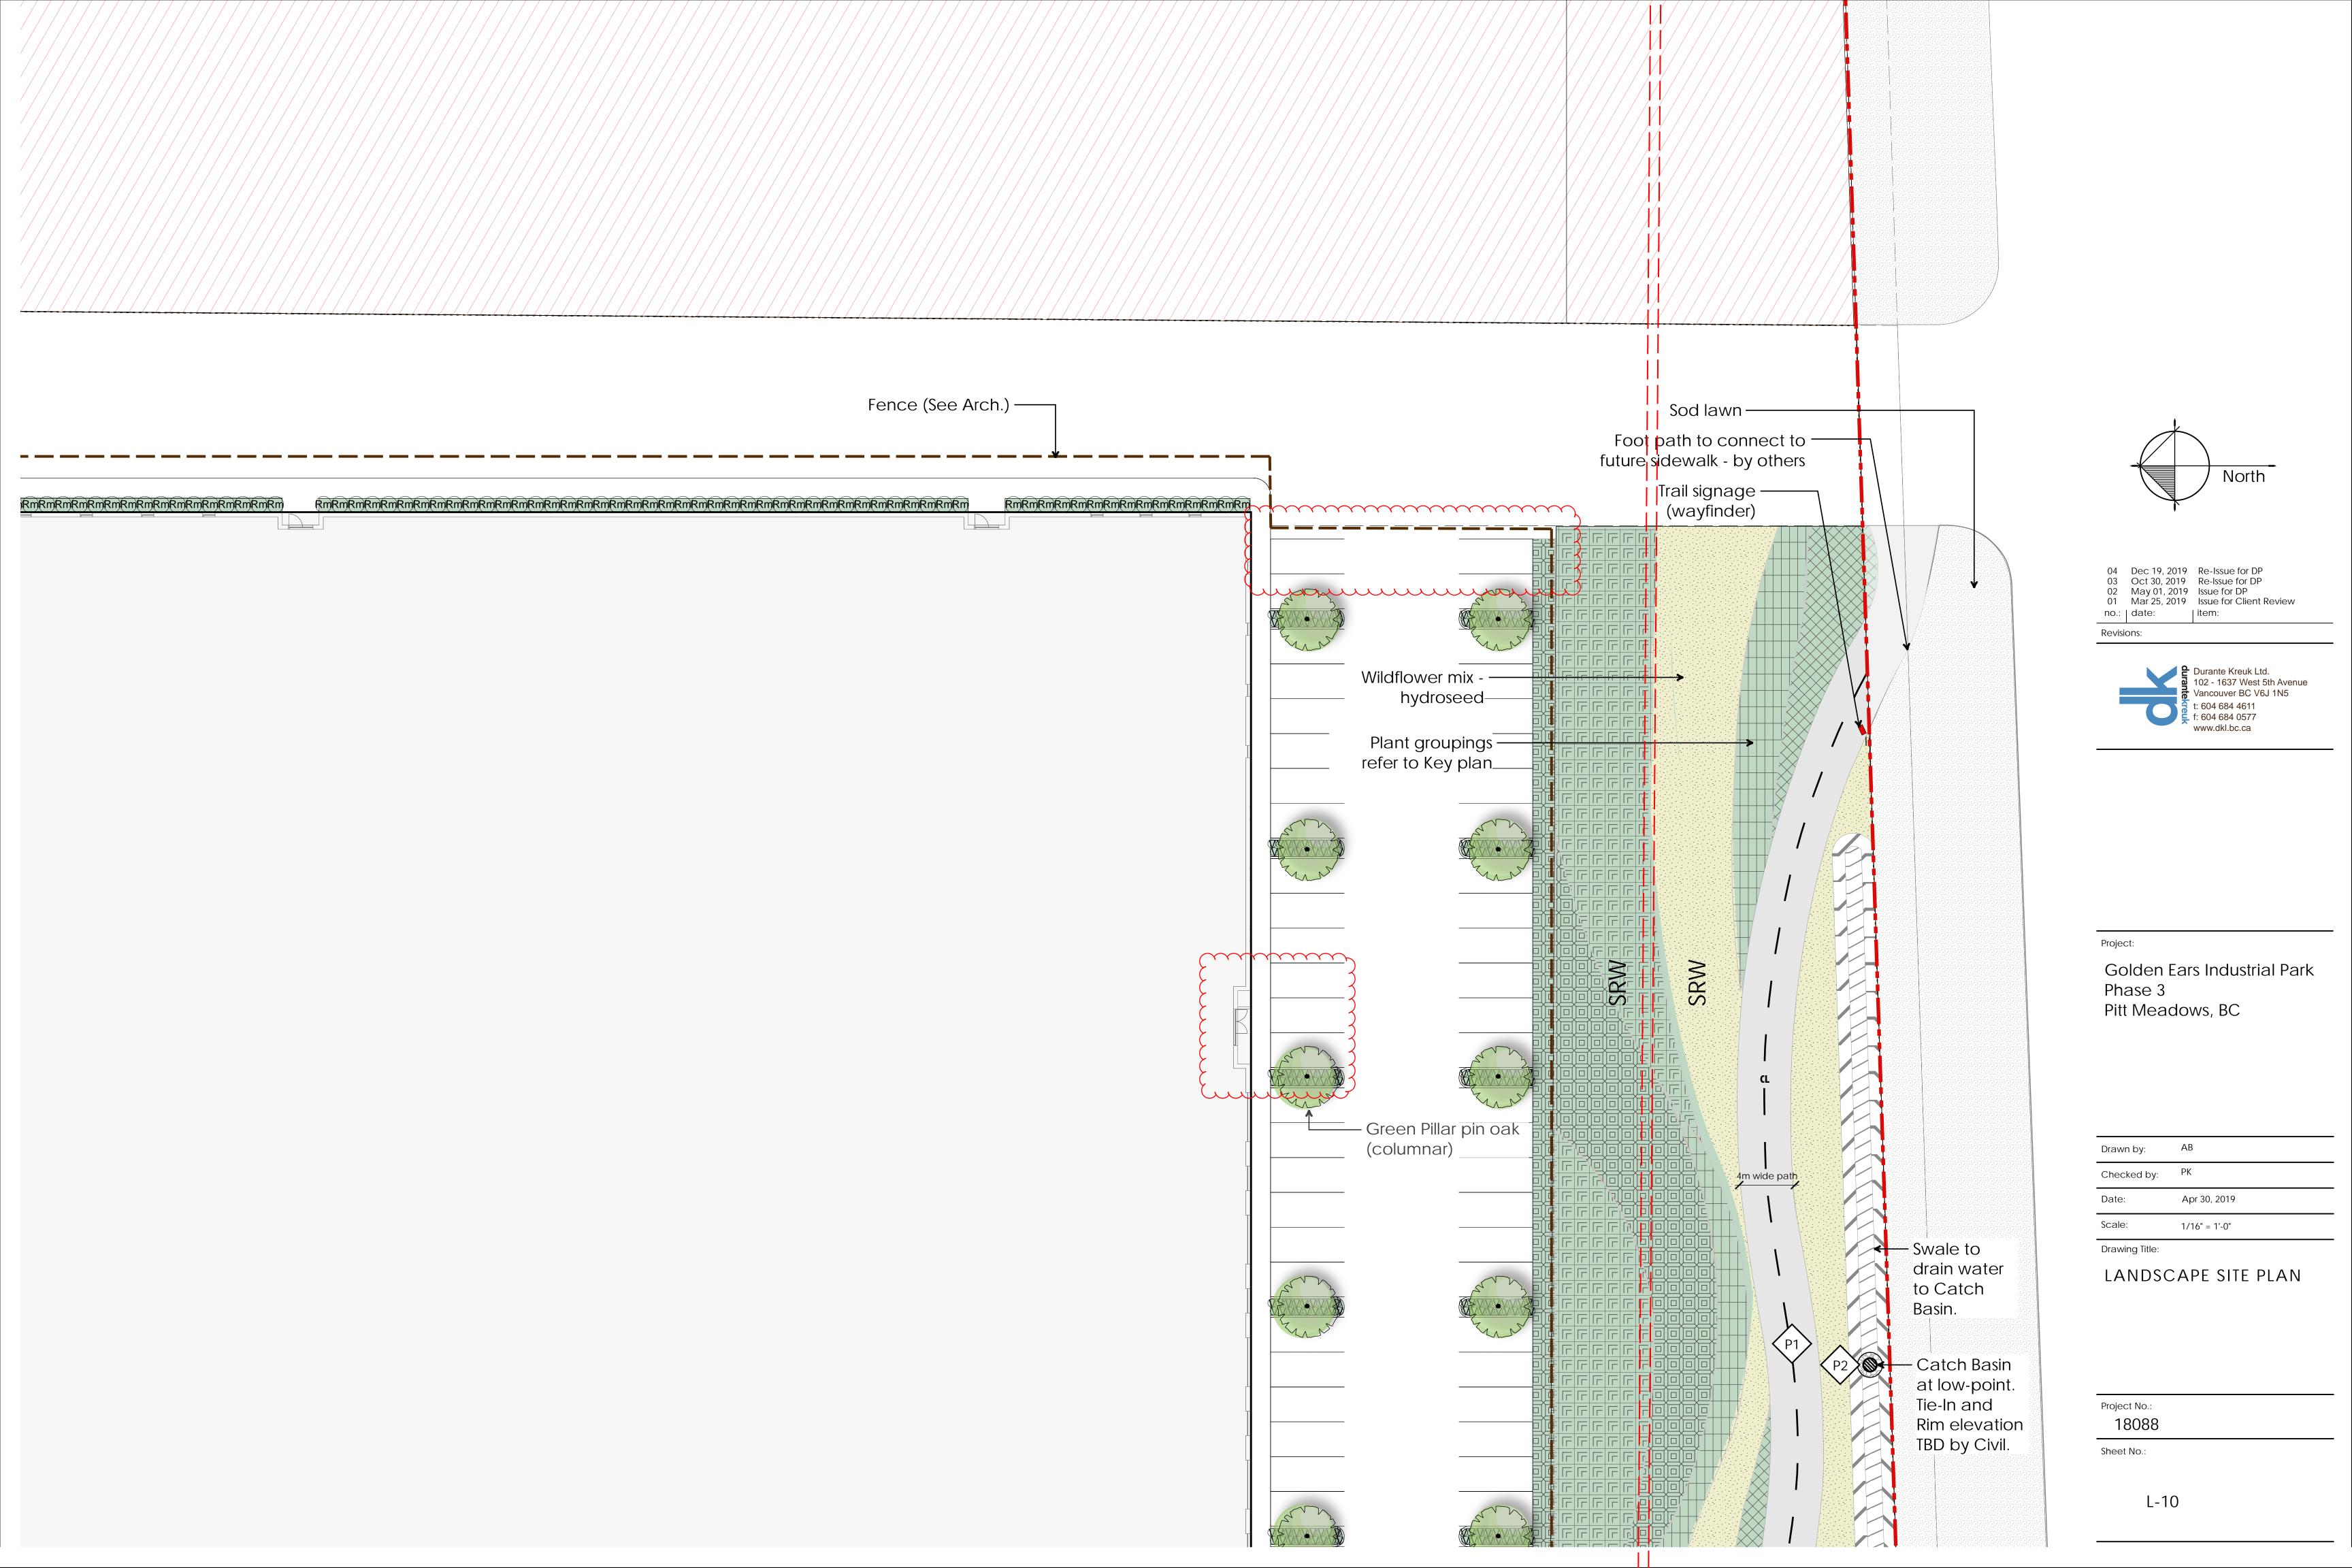

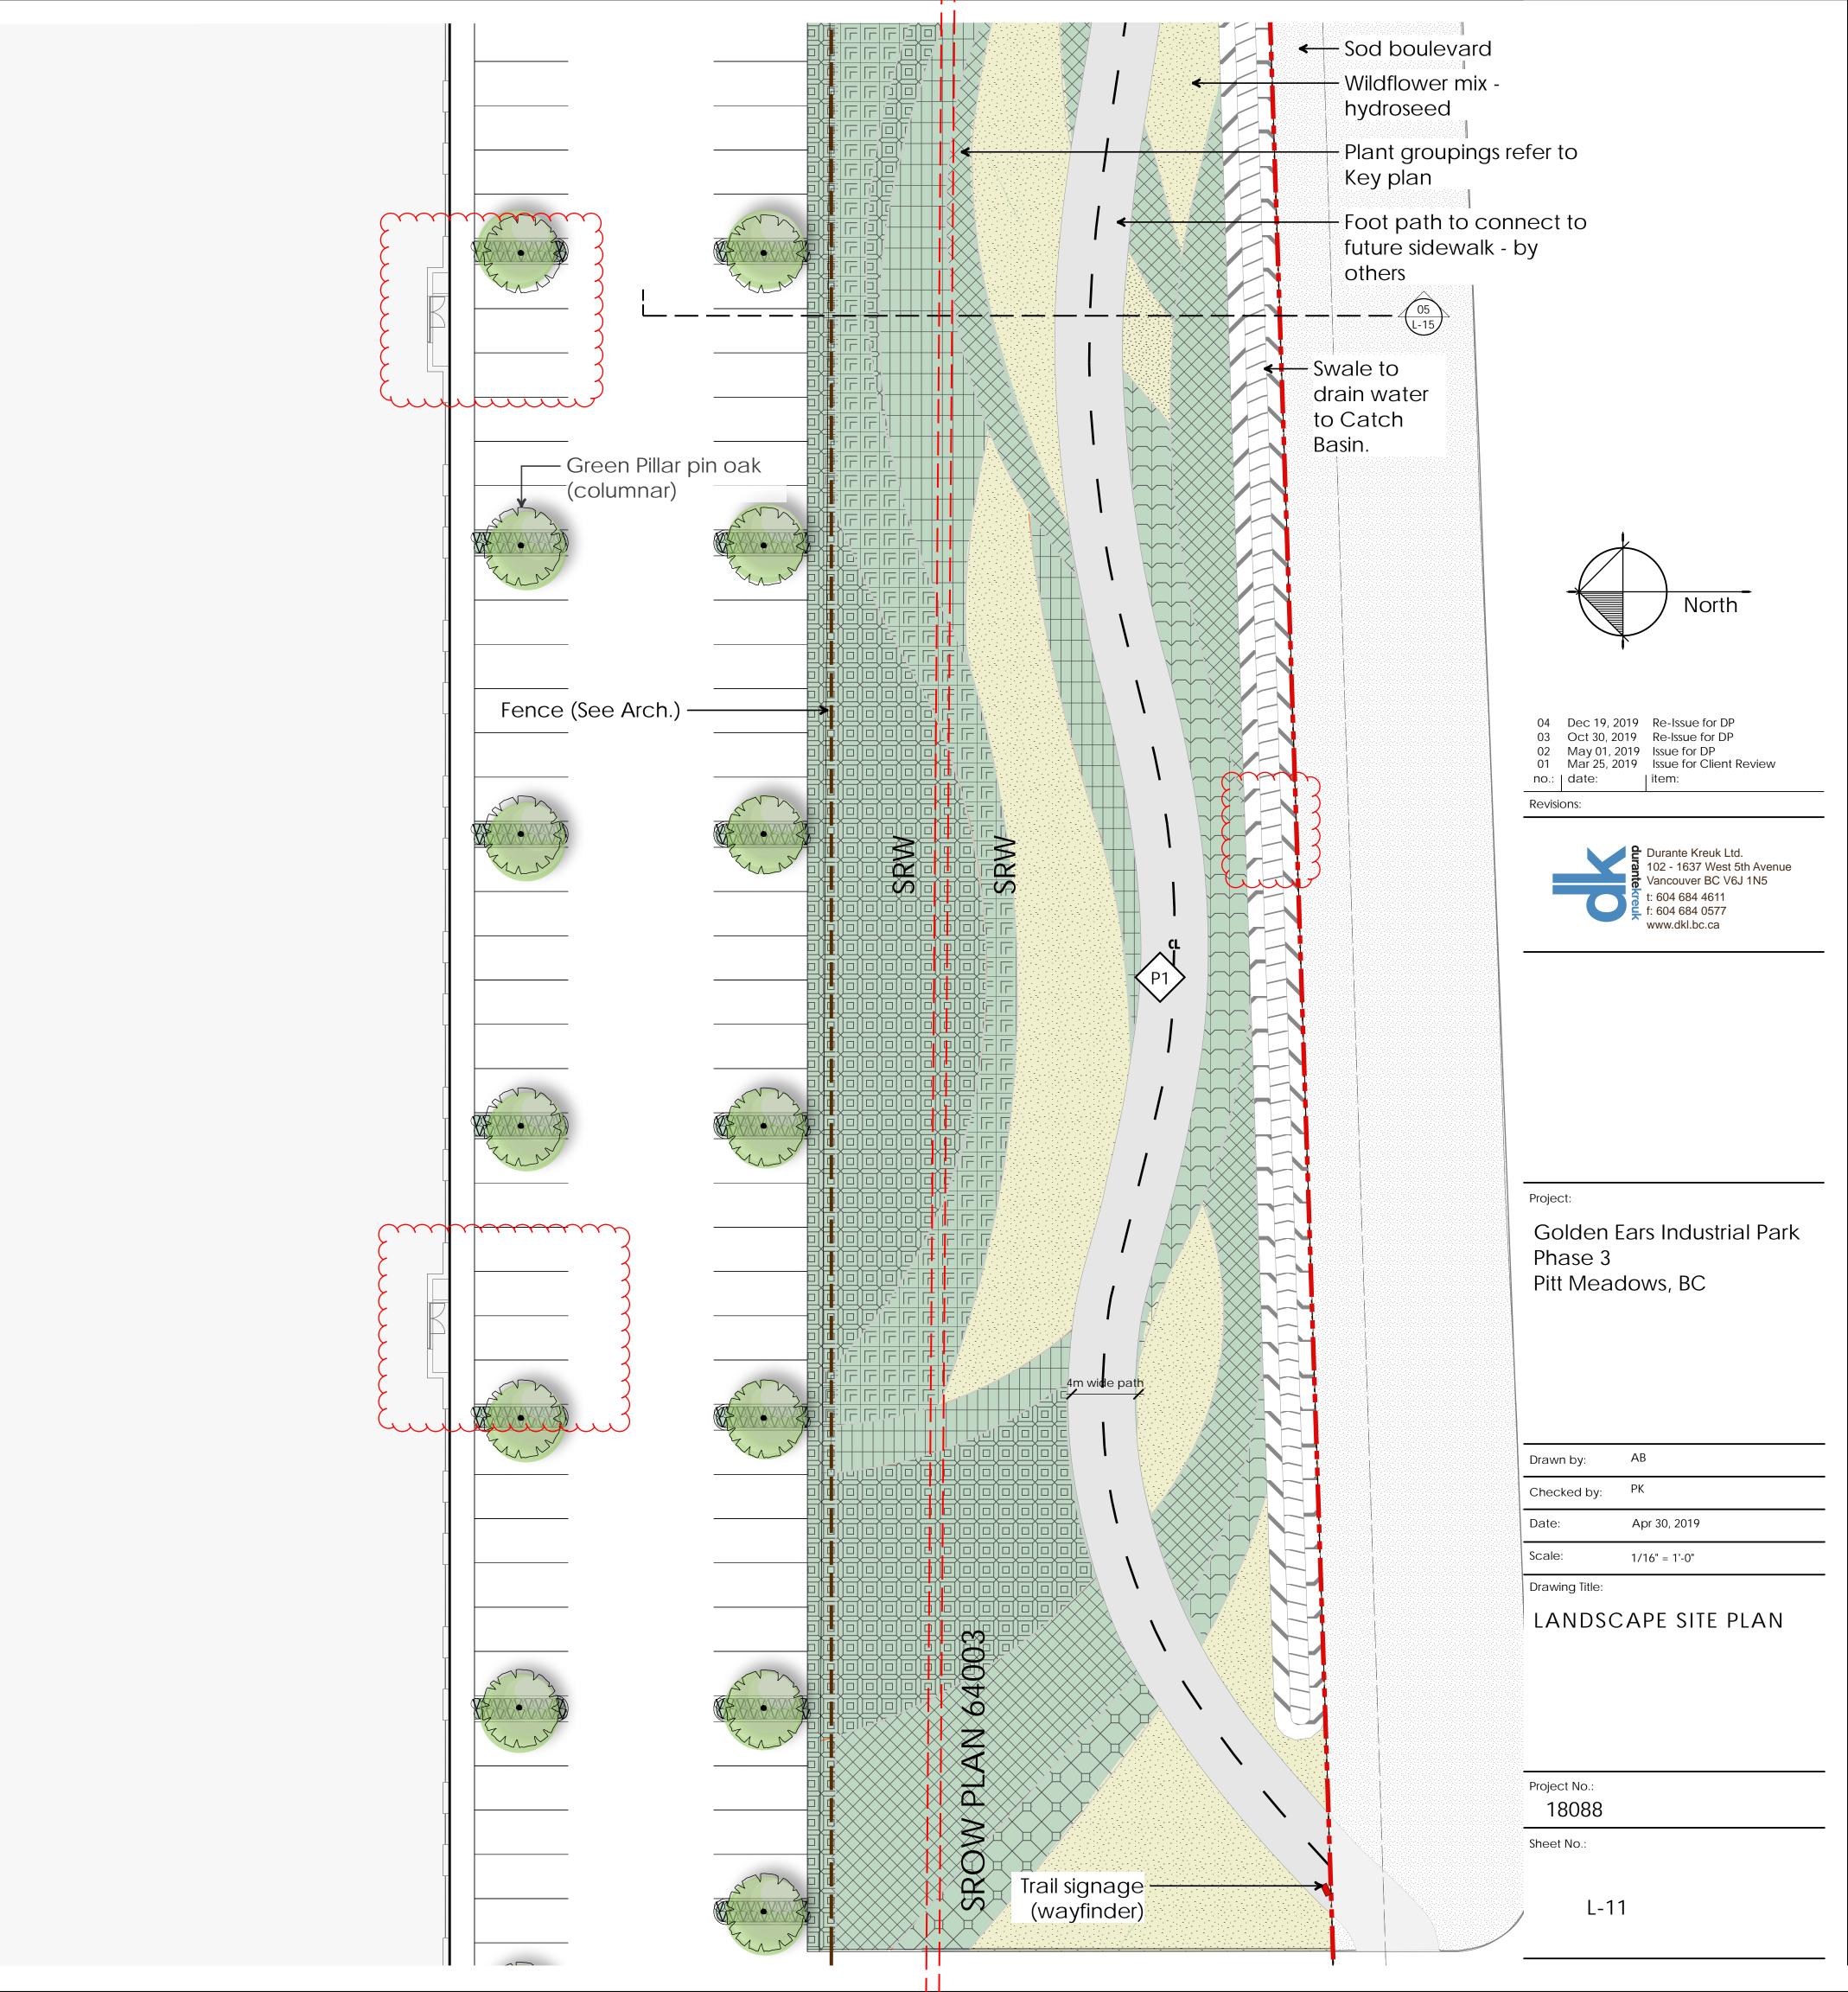 Dec 19, 2019 Re-Issue for DP
 Oct 30, 2019 Re-Issue for DP
 May 01, 2019 Issue for DP 01 Mar.25 2019 Issue for Client Review Revisions:
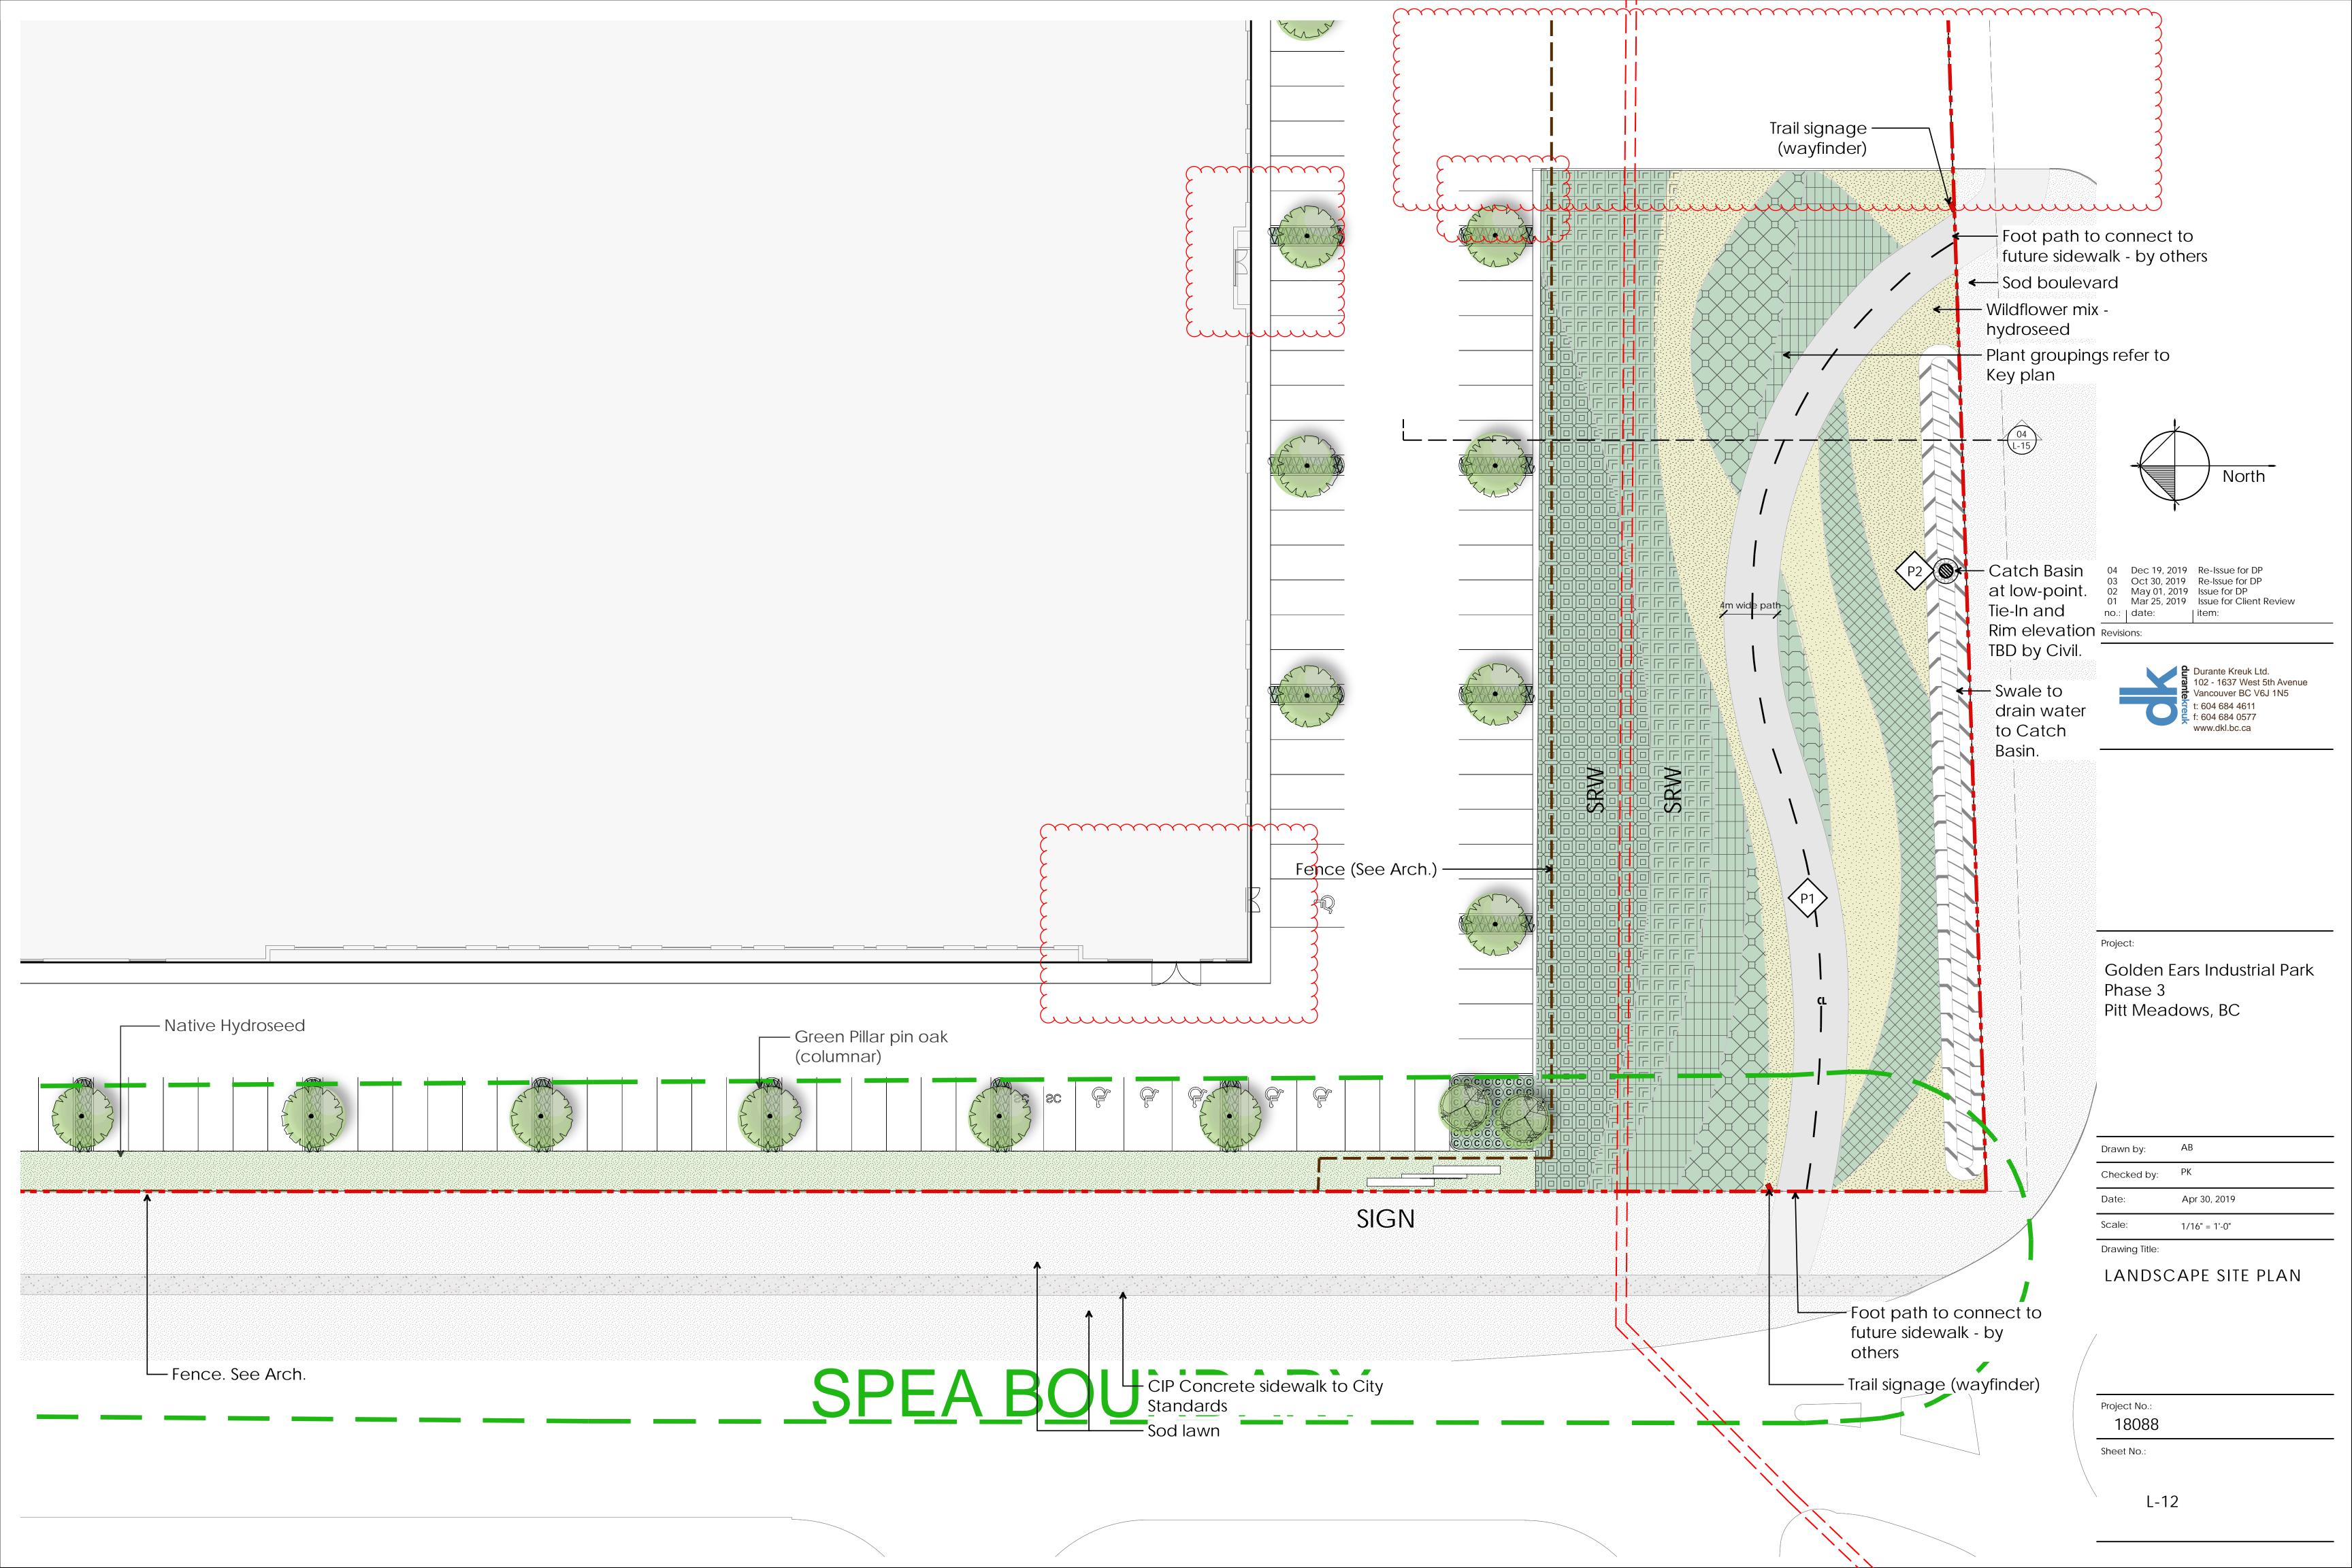
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Golden Ears Industrial Park Phase 3, Pitt Meadows, BC

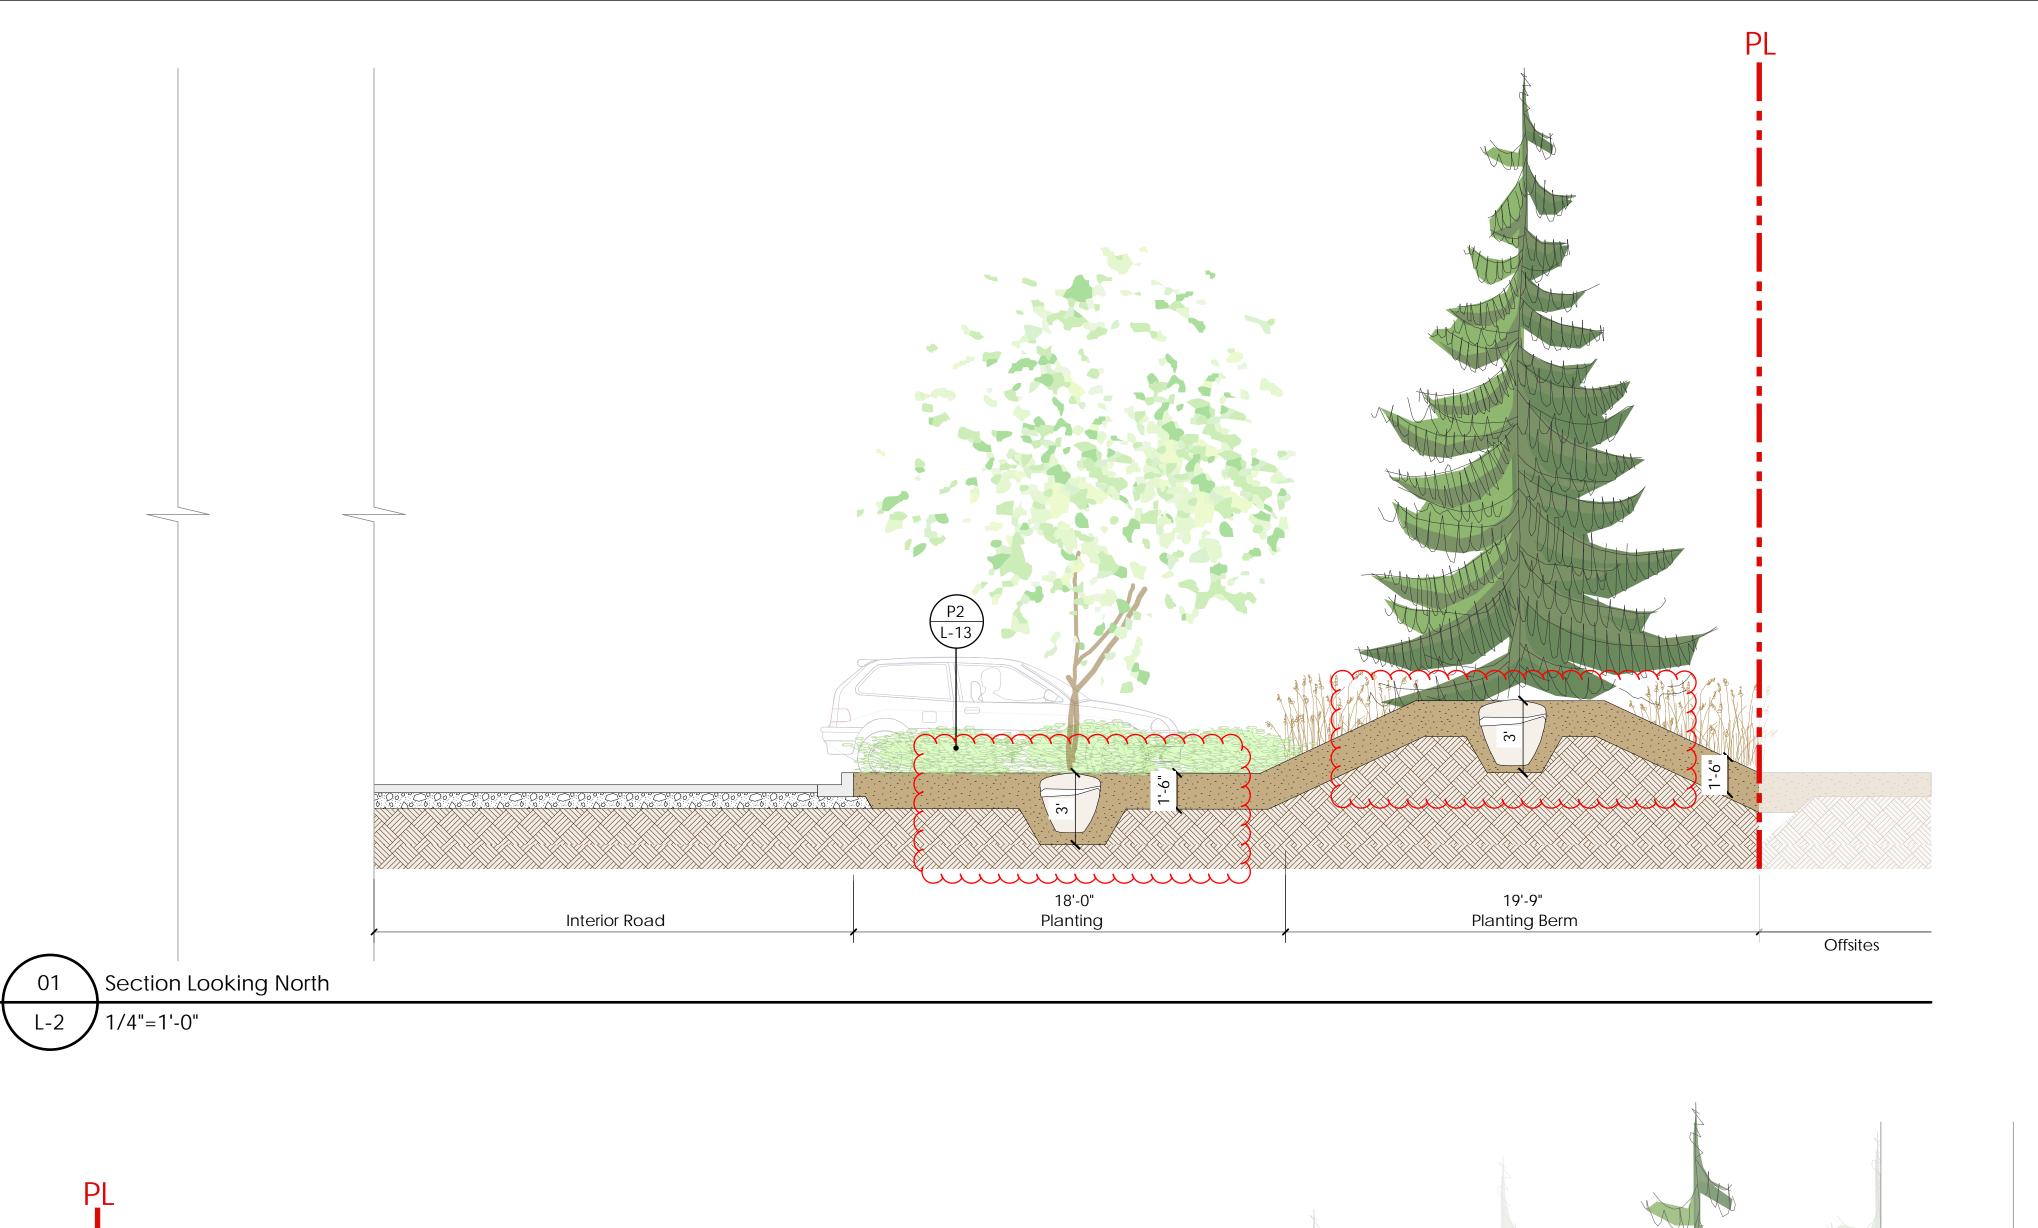
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Checked by:	AB
Date:	Apr 29, 2019
Scale:	As Shown
Drawing Title:	

Landscape Sections

Project No.: 18088 Sheet No.:

Section Looking North


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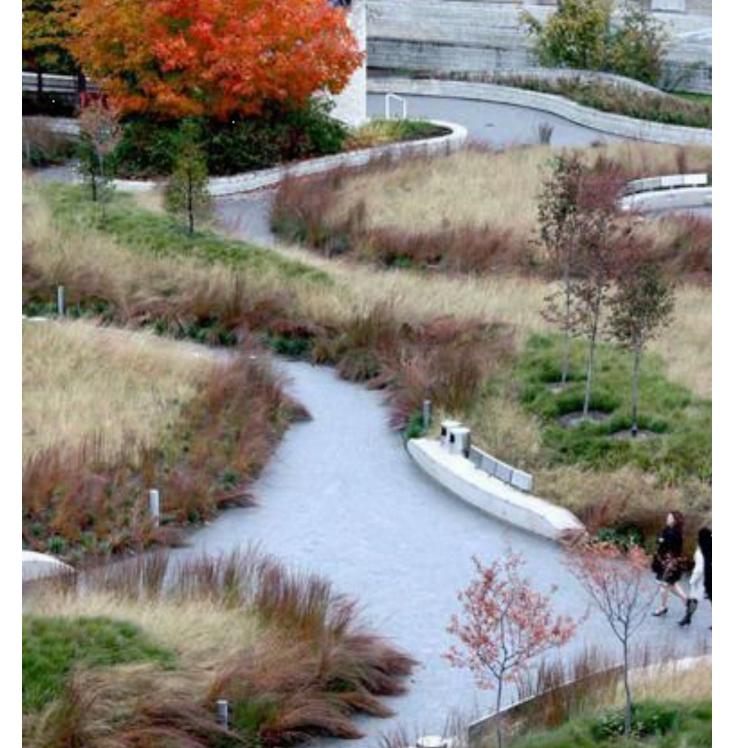


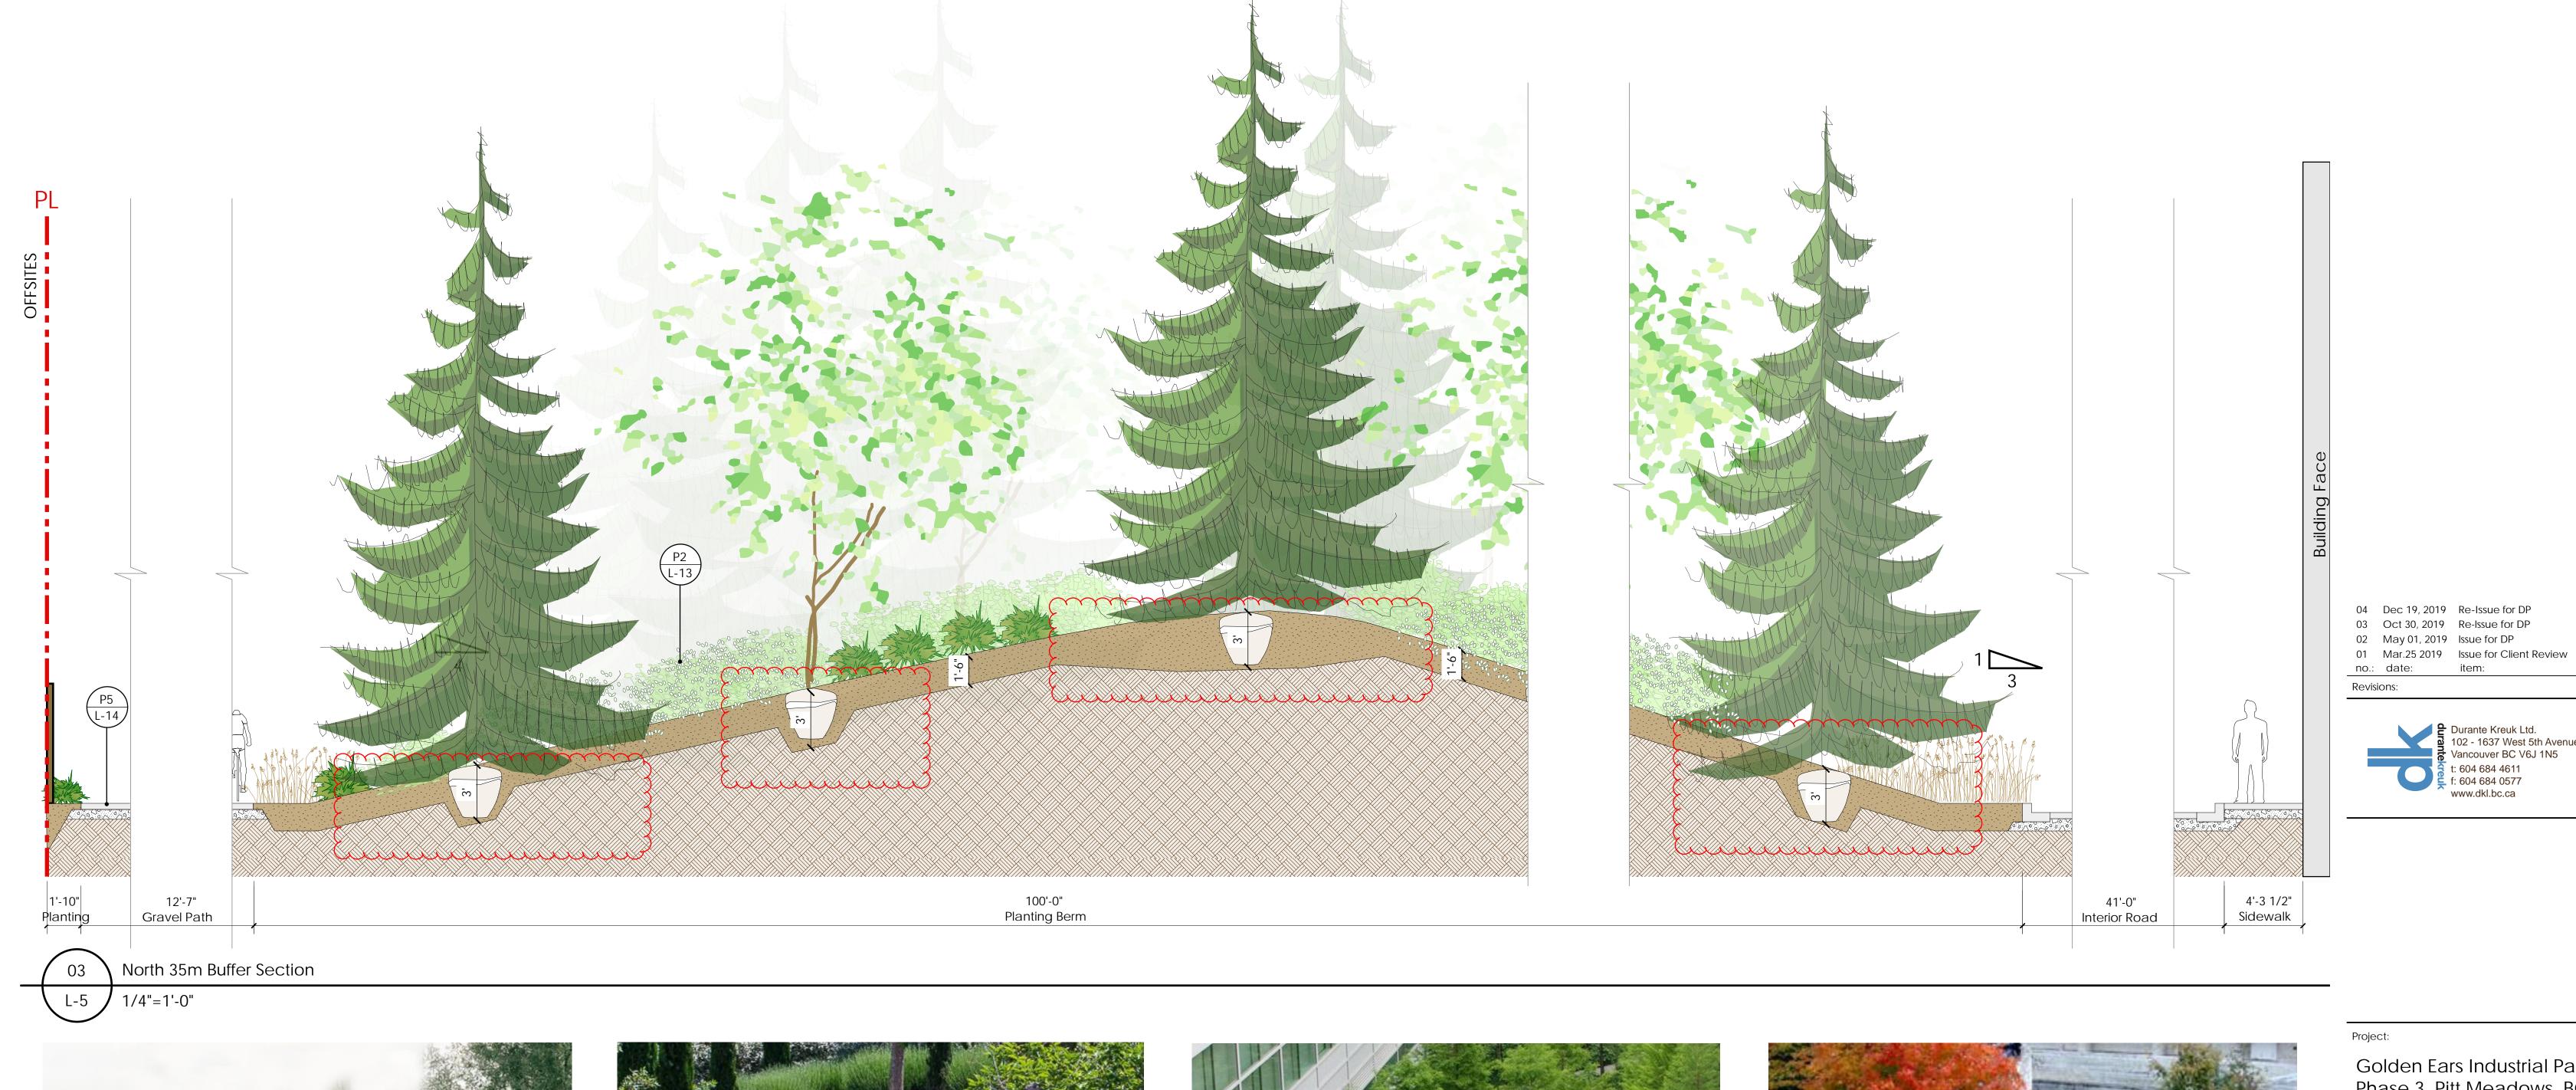Golden Ears Industrial Park Phase 3, Pitt Meadows, BC

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P6 Precedent Image: Meandering Path amongst native grasslands

Drawing Title: Landscape Sections

RO'C/TB

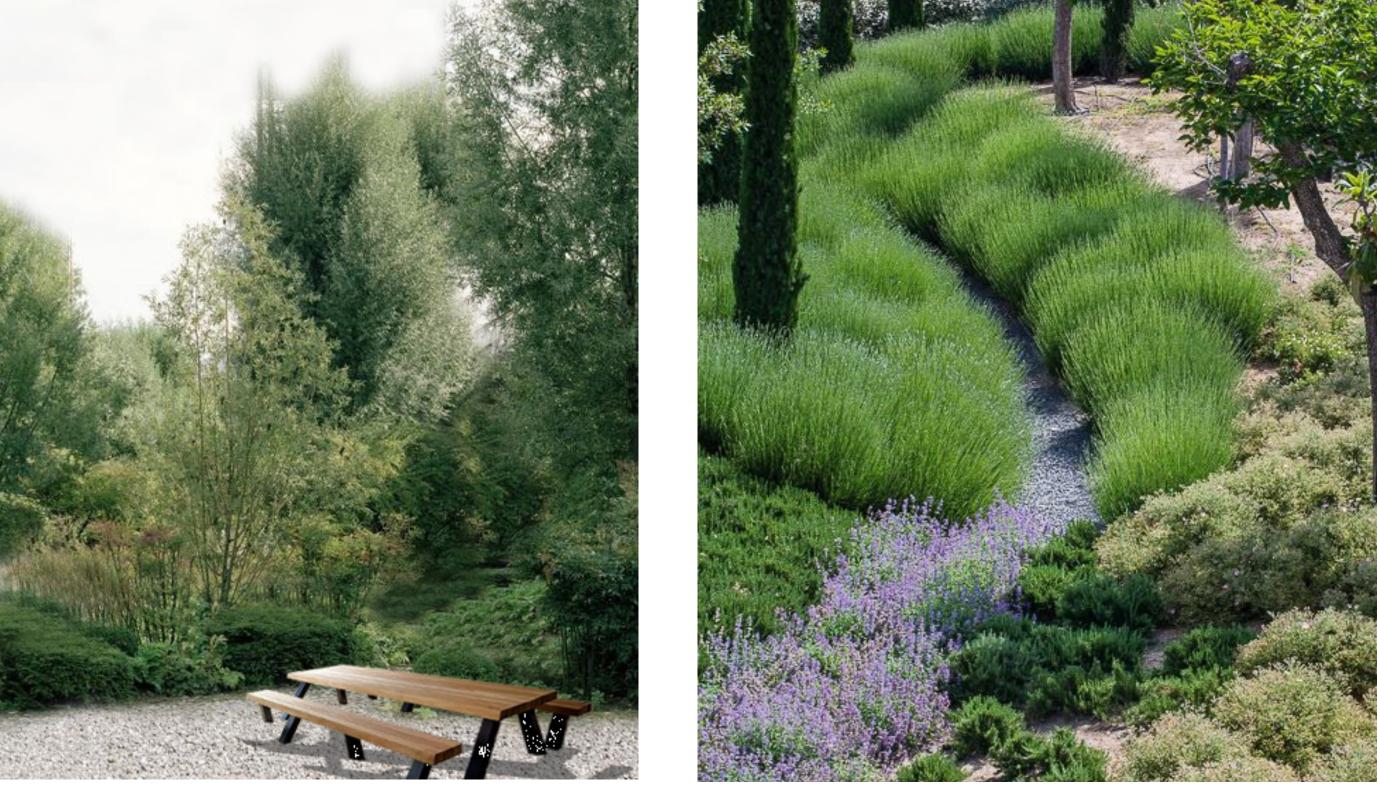Apr 29, 2019

As Shown

Project No.: 18088

Sheet No.:

Drawn by:


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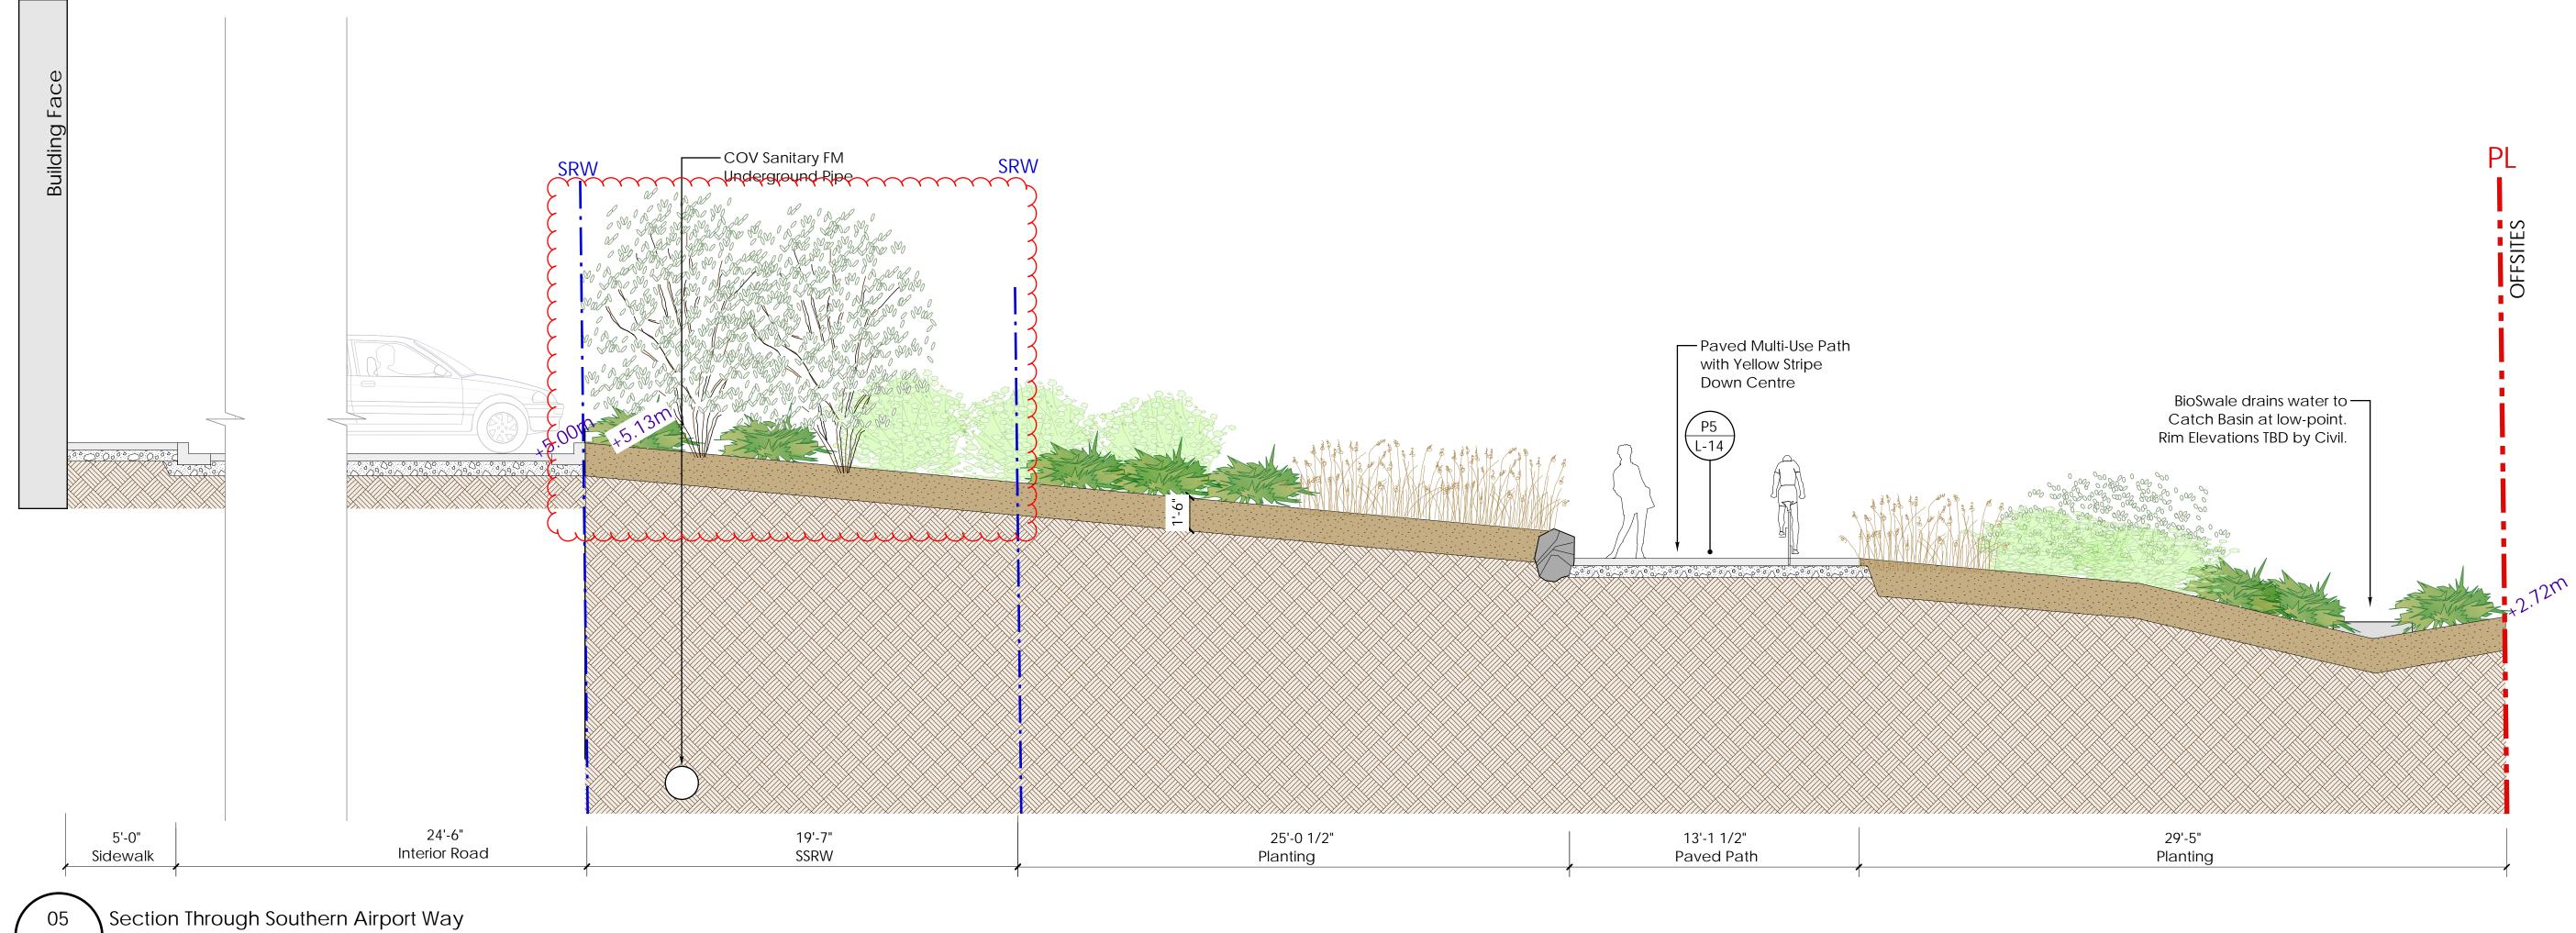
L-14

P4 Precedent Image: Picnic Areas with Custom Heavy Timbre Picnic Tables

P5 Precedent Image: Meandering Path amongst planting and trees

P3 Precedent Image: Picnic Areas with Custom Heavy Timbre Picnic Tables
L-14



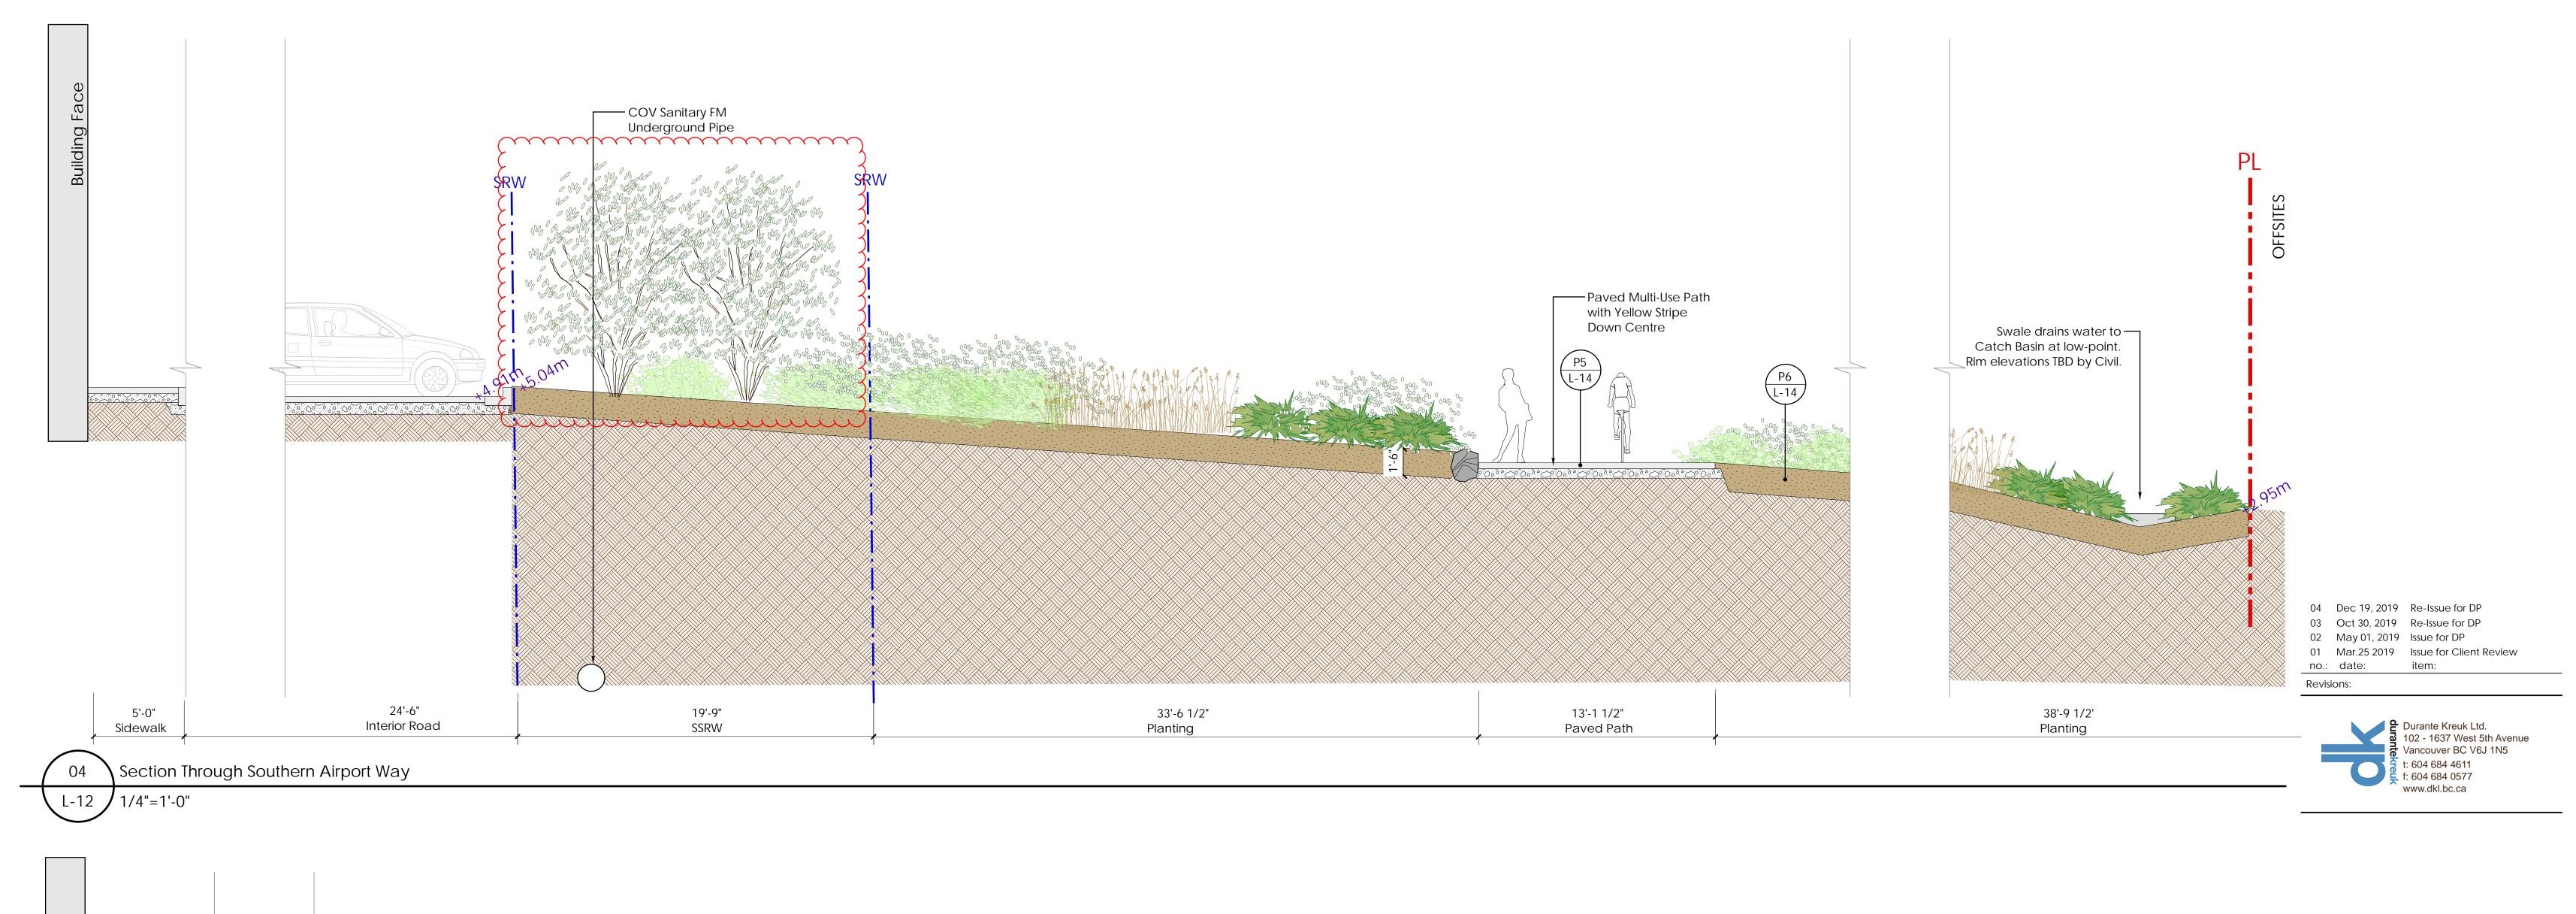

Golden Ears Industrial Park Phase 3, Pitt Meadows, BC

Drawn by:	RO'C/TB
Checked by:	AB
Date:	Apr 29, 2019
Scale:	As Shown


Drawing Title:

Landscape Sections

Project No.: 18088 Sheet No.:

L-15

1/4"=1'-0"

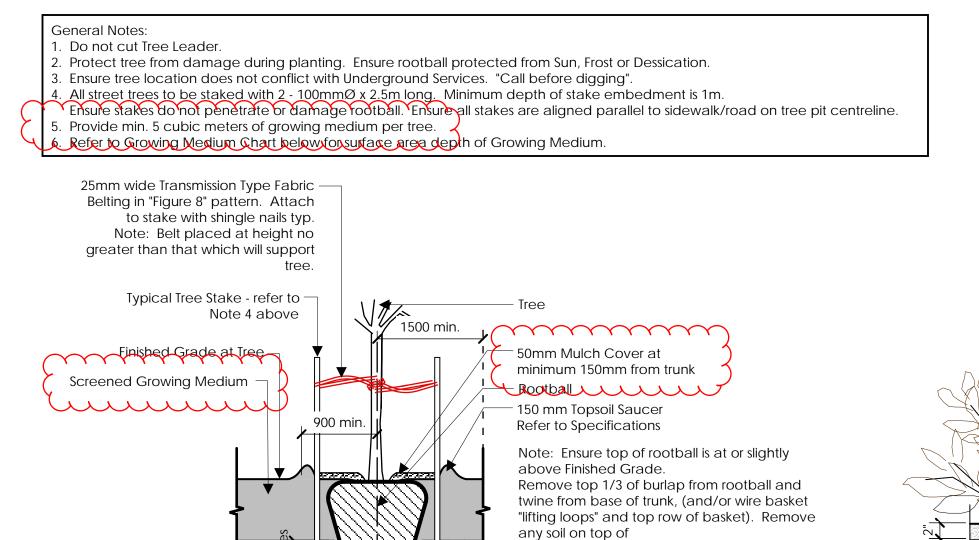

Area (M2)

8.33 6.67 Variation 1

3.3 M x 3.3 M

2.9 M x 2.9 M

2.6 M x 2.6 M

Size of Surface Square

Varies with depth of Rootball

Depth of Growing

Medium Total (mm

450

600

"original" rootball.

Do not "compact".

Variation 2

Size of Surface Circle


3.80 M Ø


3.25 M Ø


2.90 M Ø


-Scarify tree pit sides and bottom.


only to prevent settlement - min. 95% S.P.D.

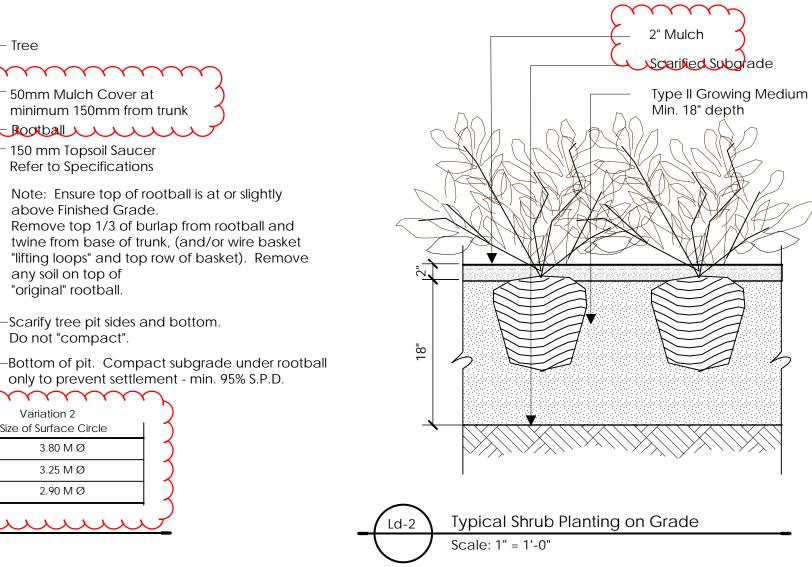

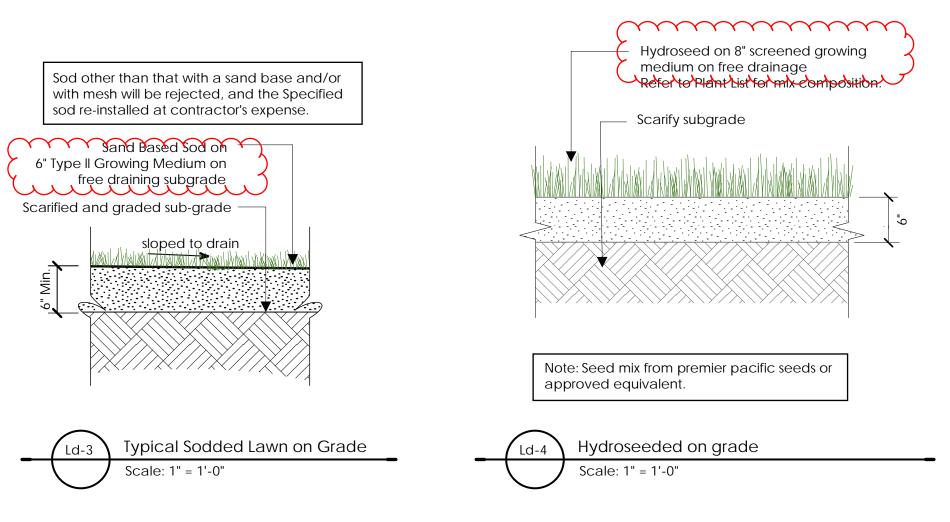


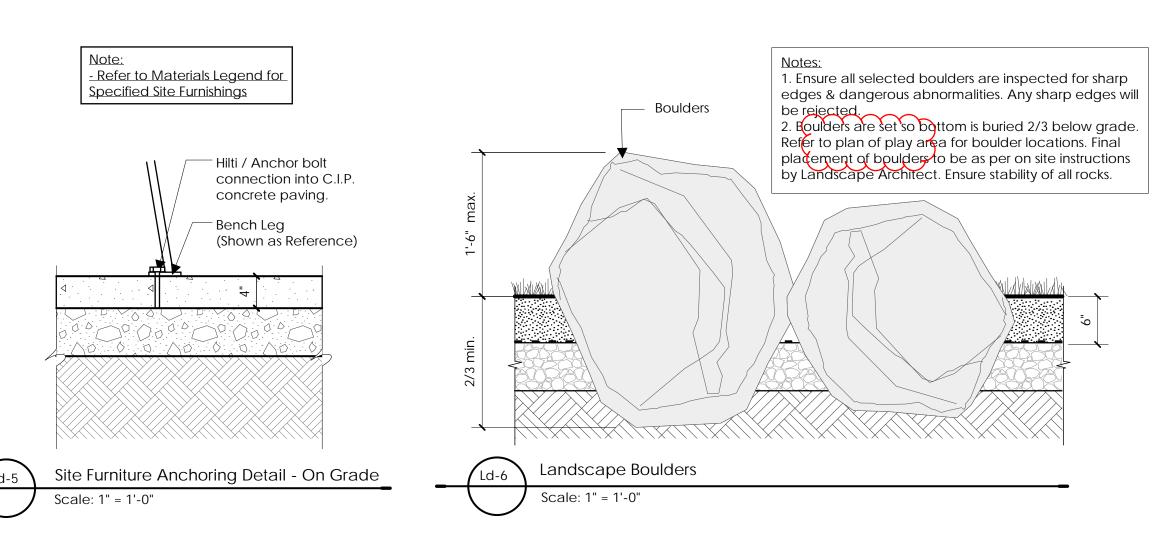

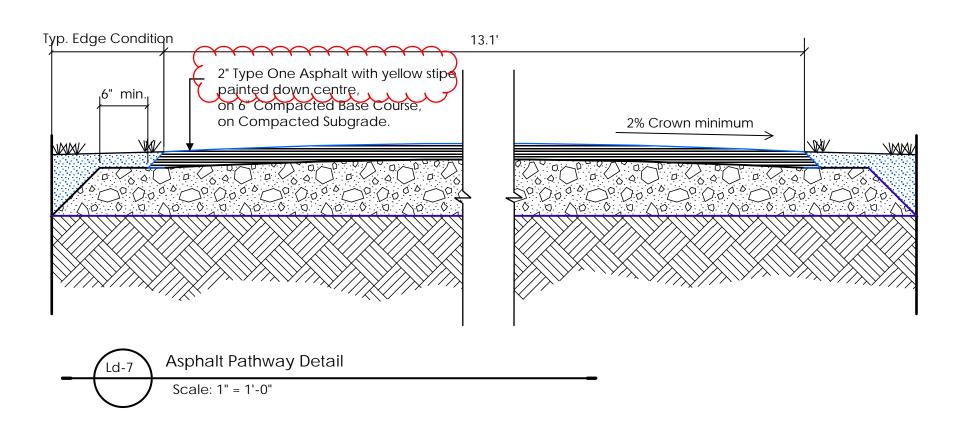

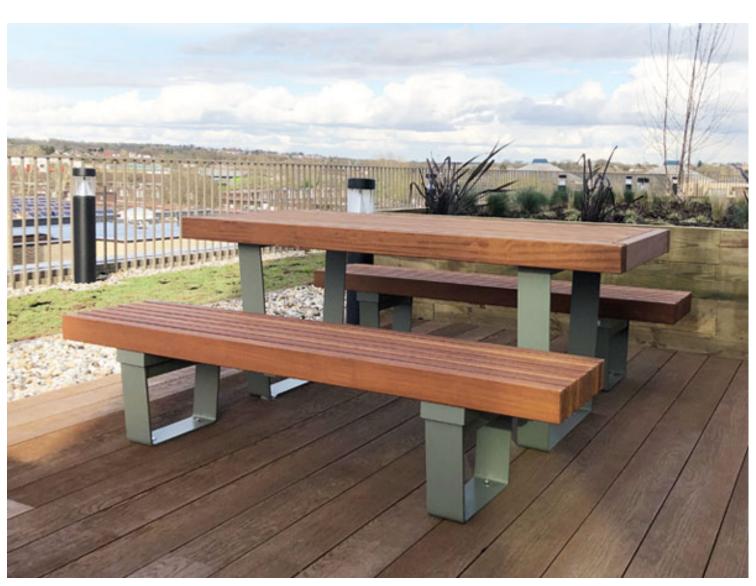

Heavy Timbre Picnic Table Precedent

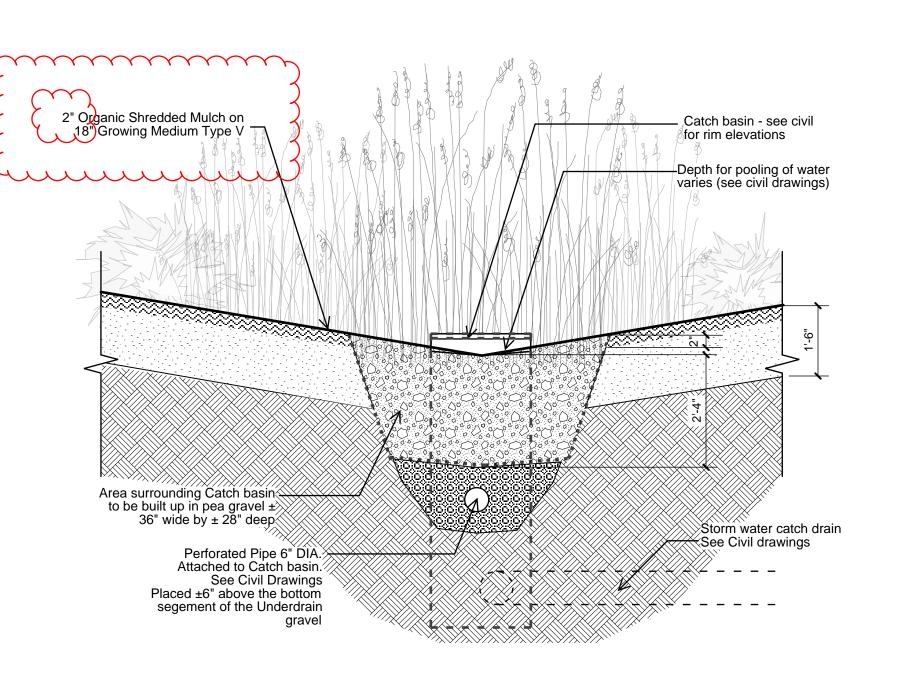

03 Oct 30, 2019 Re-Issue for DP

02 May 01, 2019 Issue for DP 01 Mar.25 2019 Issue for Client Review

04 Dec 19, 2019 Re-Issue for DP

no.: date:

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Golden Ears Industrial Park Phase 3, Pitt Meadows, BC


Drawn by:	RO'C/TB
Checked by:	AB
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Scale:	As Shown

Drawing Title:

Landscape Sections

Project No.: 18088

Sheet No.:

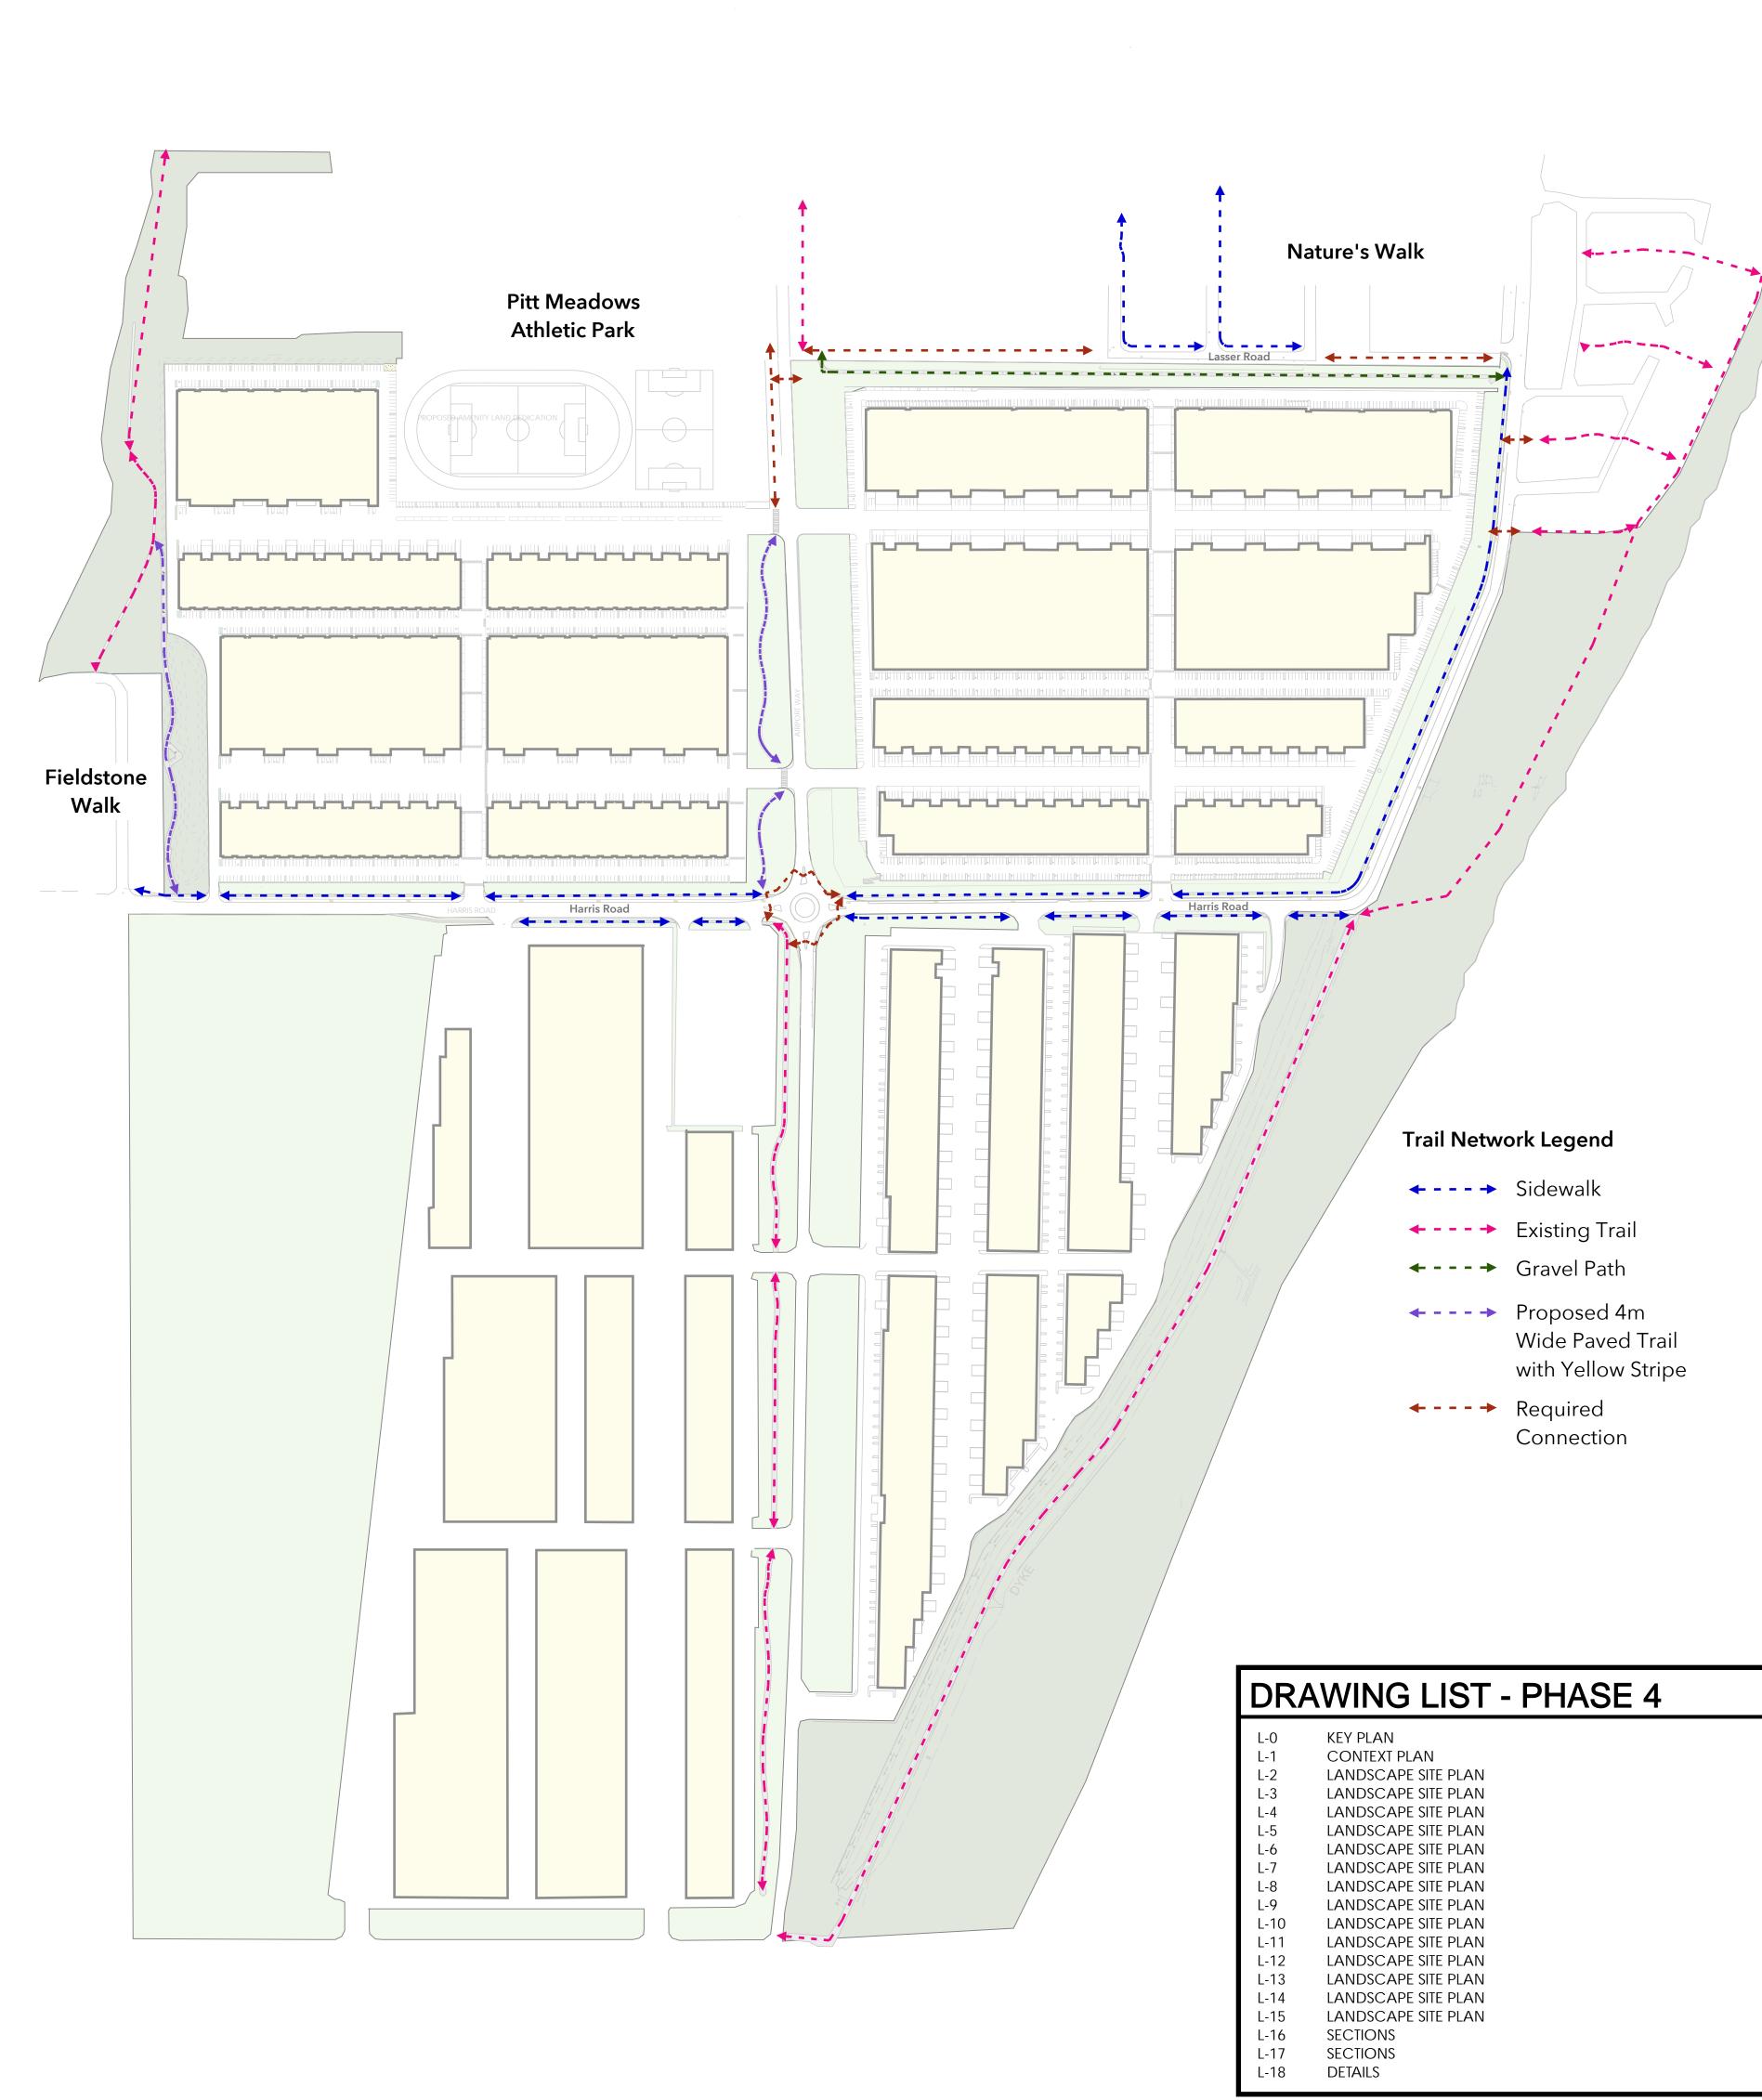

Material Legend			
Detail	Key	Material De	scription
Ld-04 L-18		Hydroseed	Wildflower Mix by Premier Pacific Seed or approved equivalent
	(==;)	Berm	
Ld-04 L-18		Hydroseed	
Ld-03 L-18		Sod Lawn (Offsite)	
Ld-02 L-18		Shrubs / Planting beds	Native Grass Seed Mix by Premier Pacific Seed or approved equivalent
Ld-07 L-18		4m Wide Asphalt Path with Yellow Stripe	
	<b>♦ F</b> -1	Bird Houses	Make and Model TBD
Ld-06 L-18	F-2	Landscape Boulders	Varies
Ld-05 L-18 Ld-08 L-18	<b>₹</b> -3	Picnic Table	Make and Model TBD
	F-4	Bench - with back	Make and Model TBD
		Monument signage with seating -refer to arch	

## **On-Site Plant List**

Sym	Qty	Botanical Name	Common Name	Size/Space
		Trees		
	<del>35</del>	Acer rubrum 'Bowhall'	Bowhall red maple	7cm cal. (col)
	<b>-</b> 5	Acer rubrum 'Sun Valley'	Sun Valley red maple	7cm cal. B+B
The state of the s	<del>-</del> 31	Acer macrophyllum	Big Leaf maple	8cm cal. WB
	<del>-</del> 139	Quercus palustris 'Green Pillar'	Green Pillar pin oak	7cm cal. B+B
The state of the s	<del>-</del> 40	Populus trembling 'Prarie Gold'	Prarie Gold trembling aspen	5cm cal. WB
	<del>-</del> 119	Pseddotsuga menzeisii	Douglas fir	3m ht WB
	<del>-</del> 32	Picea sitchensis	Sitka spruce	2m ht B+B
	<del>-</del> 40	Tsuga heterophyla	Western hemlock	2.5m ht WB
Sym/Oty	Rota	anical Name	Common Name Size/Snace/	Comments

Sym/Qty	Botanical Name	Common Name Size/Space/Comments
	Shrubs	

		3111 405		
	6780	*Arctostaphylos-uva-ursi	Kinnikinnick, bearberry	4" pot/1'-0" o.c.
	2050	*Cornus sericea 'Kelseyi'	Dward red-osier dogwood	#2 pot/30" o.c.
	1420	*Rosa nutkana	Nootka rose	#2 pot/3'-0" o.c.
	1420	*Vaccinium ovatum	Evergreen huckleberry	#2 pot/3'-0" o.c.
	6,898	Pacysandra terminalis	Japanese spurge	#1 pot/1'-0" o.c.
	1601	Lonicera pileata	Box-leaved honeysuckle	#2pot/2'-0" o.c.
$\bigcirc$	107	Viburnum davidii	David's viburnum	#2pot/2'-0" o.c.
+	107	Taxus x media 'Hicksii'	Hicks yew (male only)	1.5m ht/B+B/RB-RB

Asterix (\*) Plant in groupings of 35 - 50 (Plant arctostaphylus only at edge - consultant to determine on site)

### General Notes


- All plants / planting to be per BCNTA and BCSLA standards.
- Plant selection subject to availability at the time of planting. Contractor shall source specified plant material and only after area of search has been exhausted will substitutions be considered.
- All trees to be staked in accordance with BCNTA Standards. All plants to be sourced from nurseries certified free of P. ramorum.
- 6. Plant sizes and related container classes are specified according to the B.C. Landscape Standards current edition. For container classes #3 and smaller, plant sizes shall be as shown in the plant list and the standard; for all other plants, both plant size and container calls shall be as shown in the plant list, Specifically, when the plant list calls for #5 class containers, these shall be as defined in the BCNTA (ANSI) Standard. 7. All offsite trees to have minimum 15 cubic meters of growing medium unless otherwise specified.

### www

- Soil Preparation and Placement Notes . All growing medium placed on project to meet or exceed BCNTA and B.C Landscape Standards latest edition.
- 2. Submit sieve analysis by an approved independent soil testing laboratory for each type of growing medium being used on the project PRIOR to placement for review and approval. Clearly identify source and type for each. Resubmit as required until growing medium is approved. Provide one composite sample of each type of proposed growing medium for each different application within the project. Minimum 1 litre physical sample.
- Submittals shall be made at least seven (7) days prior placement.
   Contractor shall not move or work growing medium or additives when they are excessively wet, extremely dry, or frozen or in any manner which will adversely affect growing medium structure. Growing medium whose structure has been destroyed by handling under these conditions will be rejected. Growing medium shall not be handled in wet or frozen conditions.

### Irrigation Notes (Design-Build System)

- 1. Irrigation to be provided for all 'Soft Landscape Areas' (unless otherwise specified) shown on the drawing.
- 2. All 'Soft Landscape Areas' are to be irrigated with high efficiency design build irrigation system to IIABC Standards, c/w rain sensor unless
- 3. All irrigation valve boxes equipped with quick-couplers.
- 4. Layout of the system and installation shall be to trade standards for projects of this scale and type, to provide for uniform complete "head to head" coverage of all lawn and planted areas within the area as designated on the drawings.
- 5. Record Drawings: Submit with the operating and maintenance manuals, a reproducible copy of the as-built condition of the system. 6. Instruct a designated representative of the Owner in the complete operating and maintenance procedures for that system, including
- winterizing the system for the first time with the designated representative observing. NOTE: Sleeving @ roadways to use schedule 40 cast iron sleeving.
- 1. The irrigation system design and installation shall be in accordance with the Irrigation Industry of BC Standards and Guidelines.
- 2.All irrigation work shall be done by an experienced and competent irrigation contractor having the facilities and personnel adequate for the work specified. Minimum standard to IIABC.

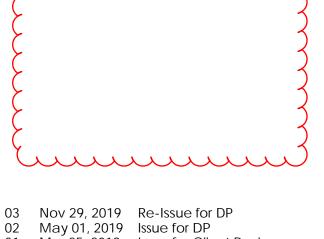

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Golden Ears Industrial Park Phase 4 Pitt Meadows, BC

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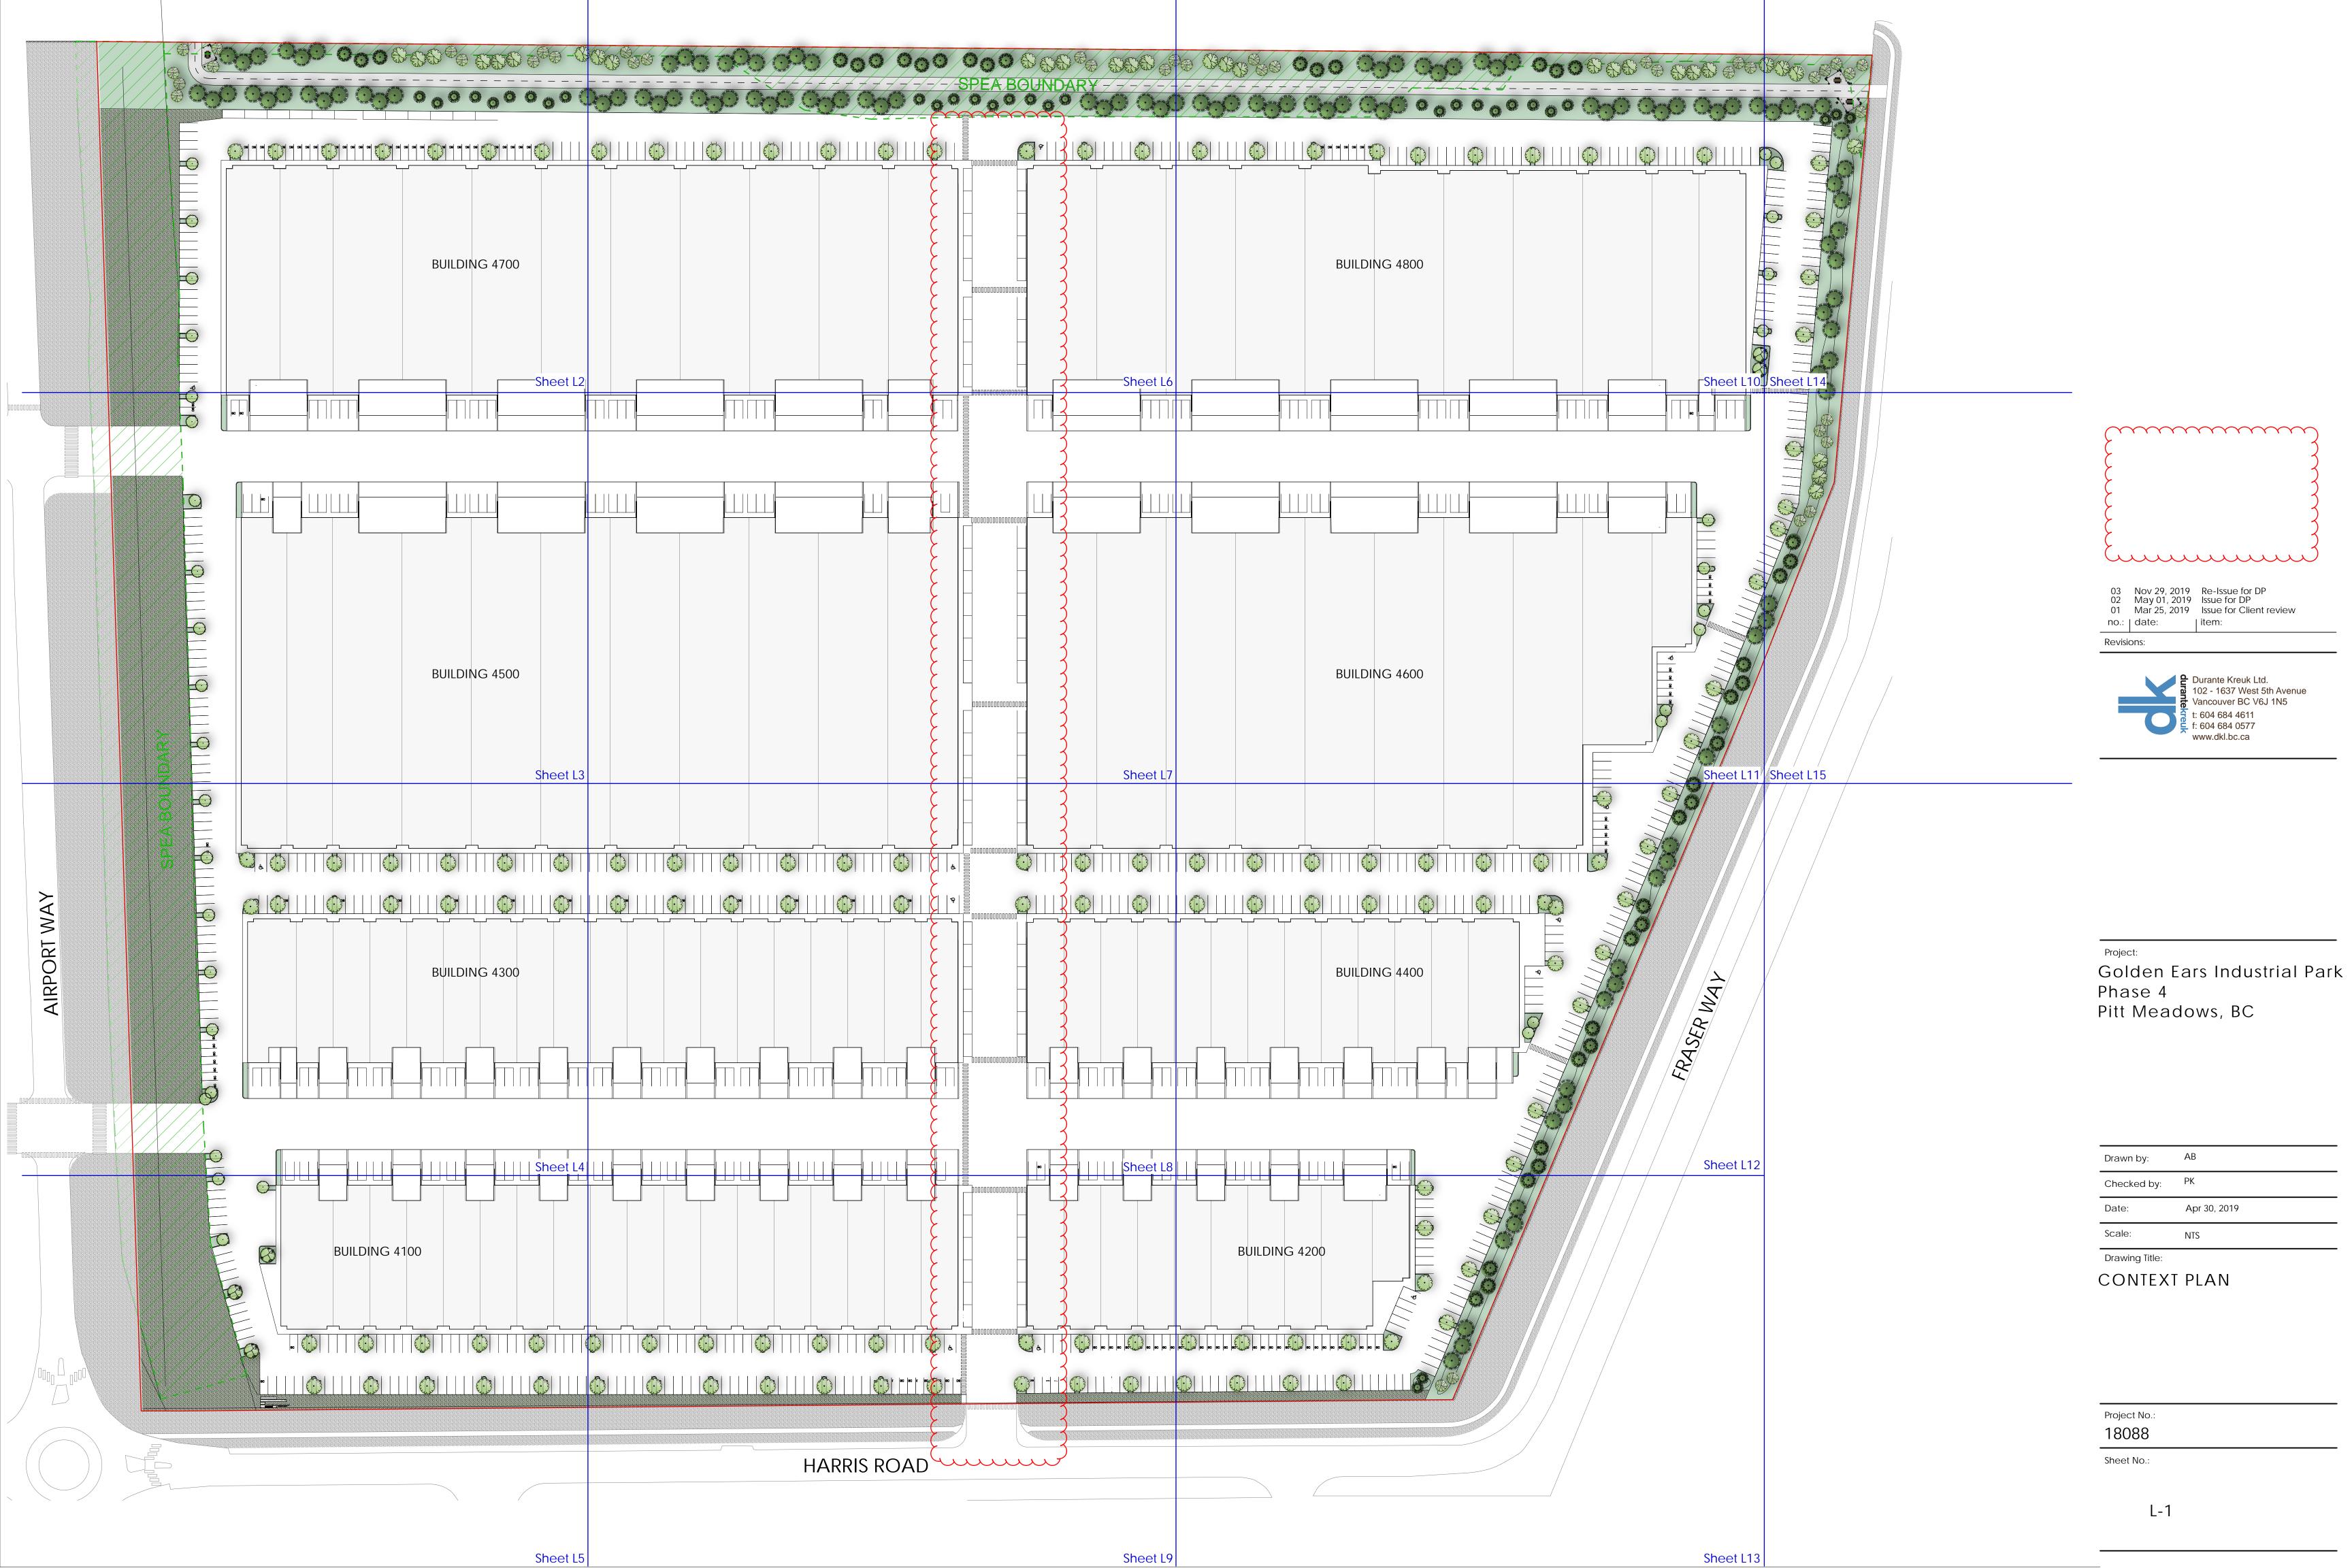
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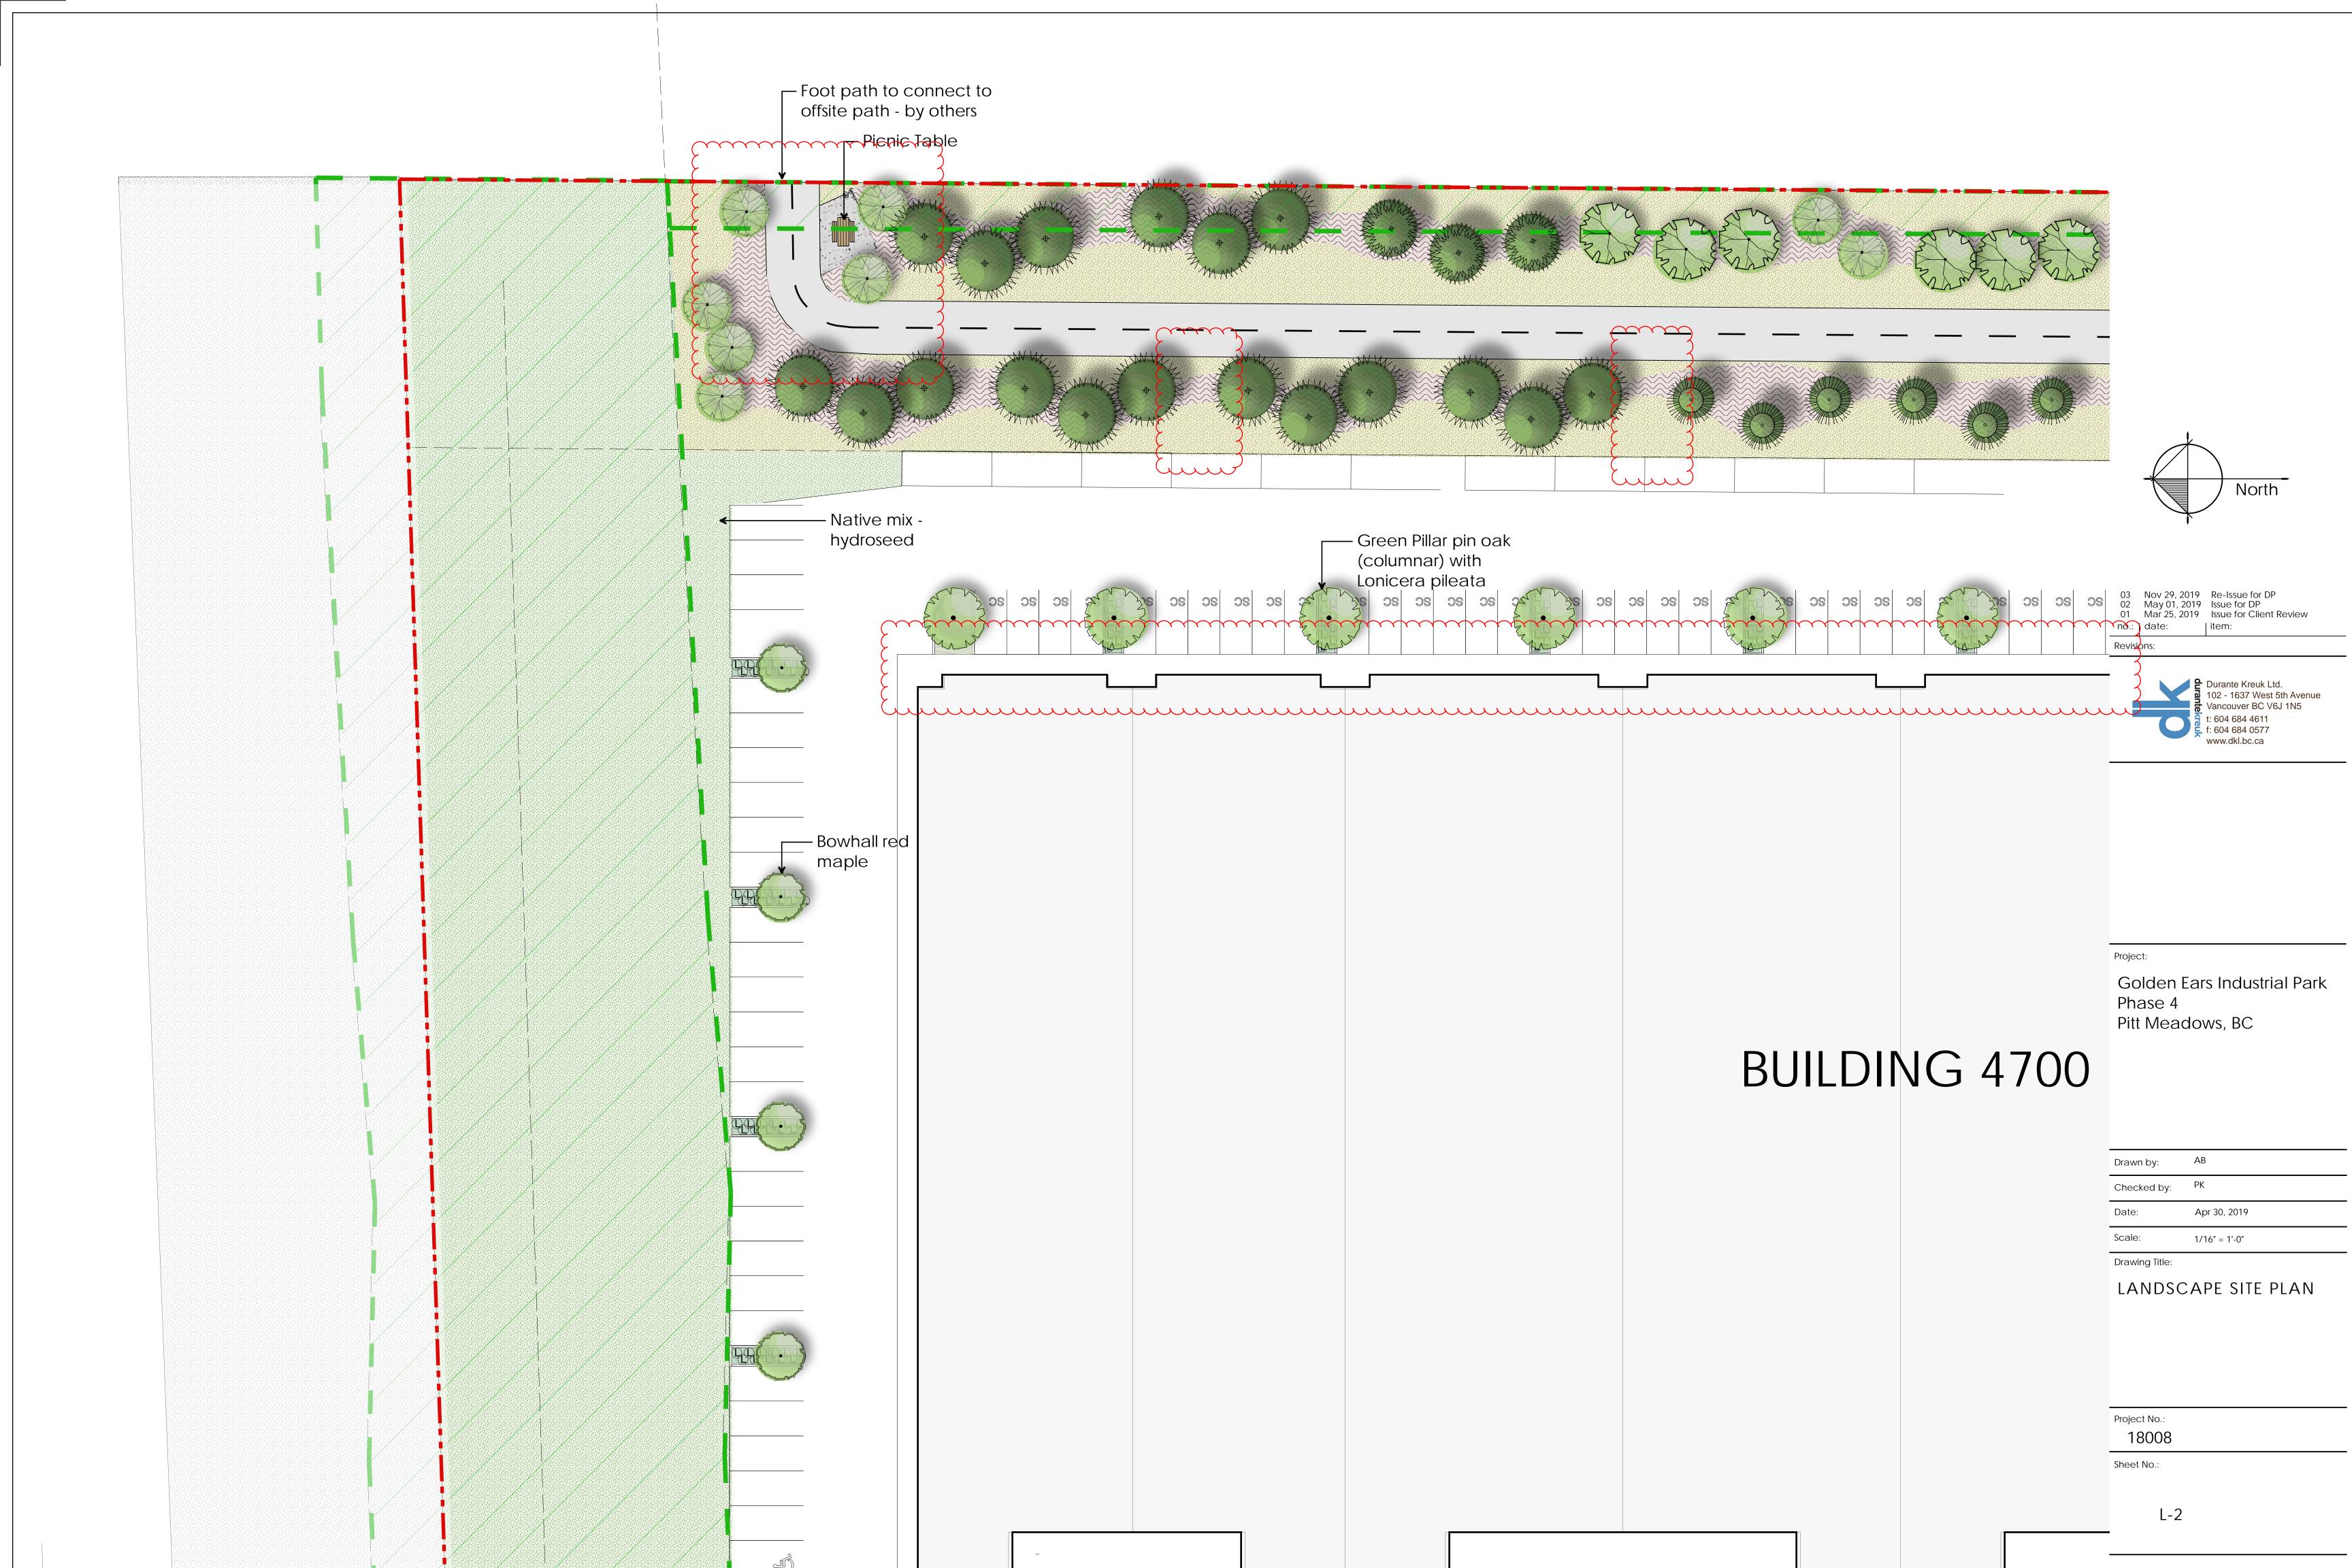
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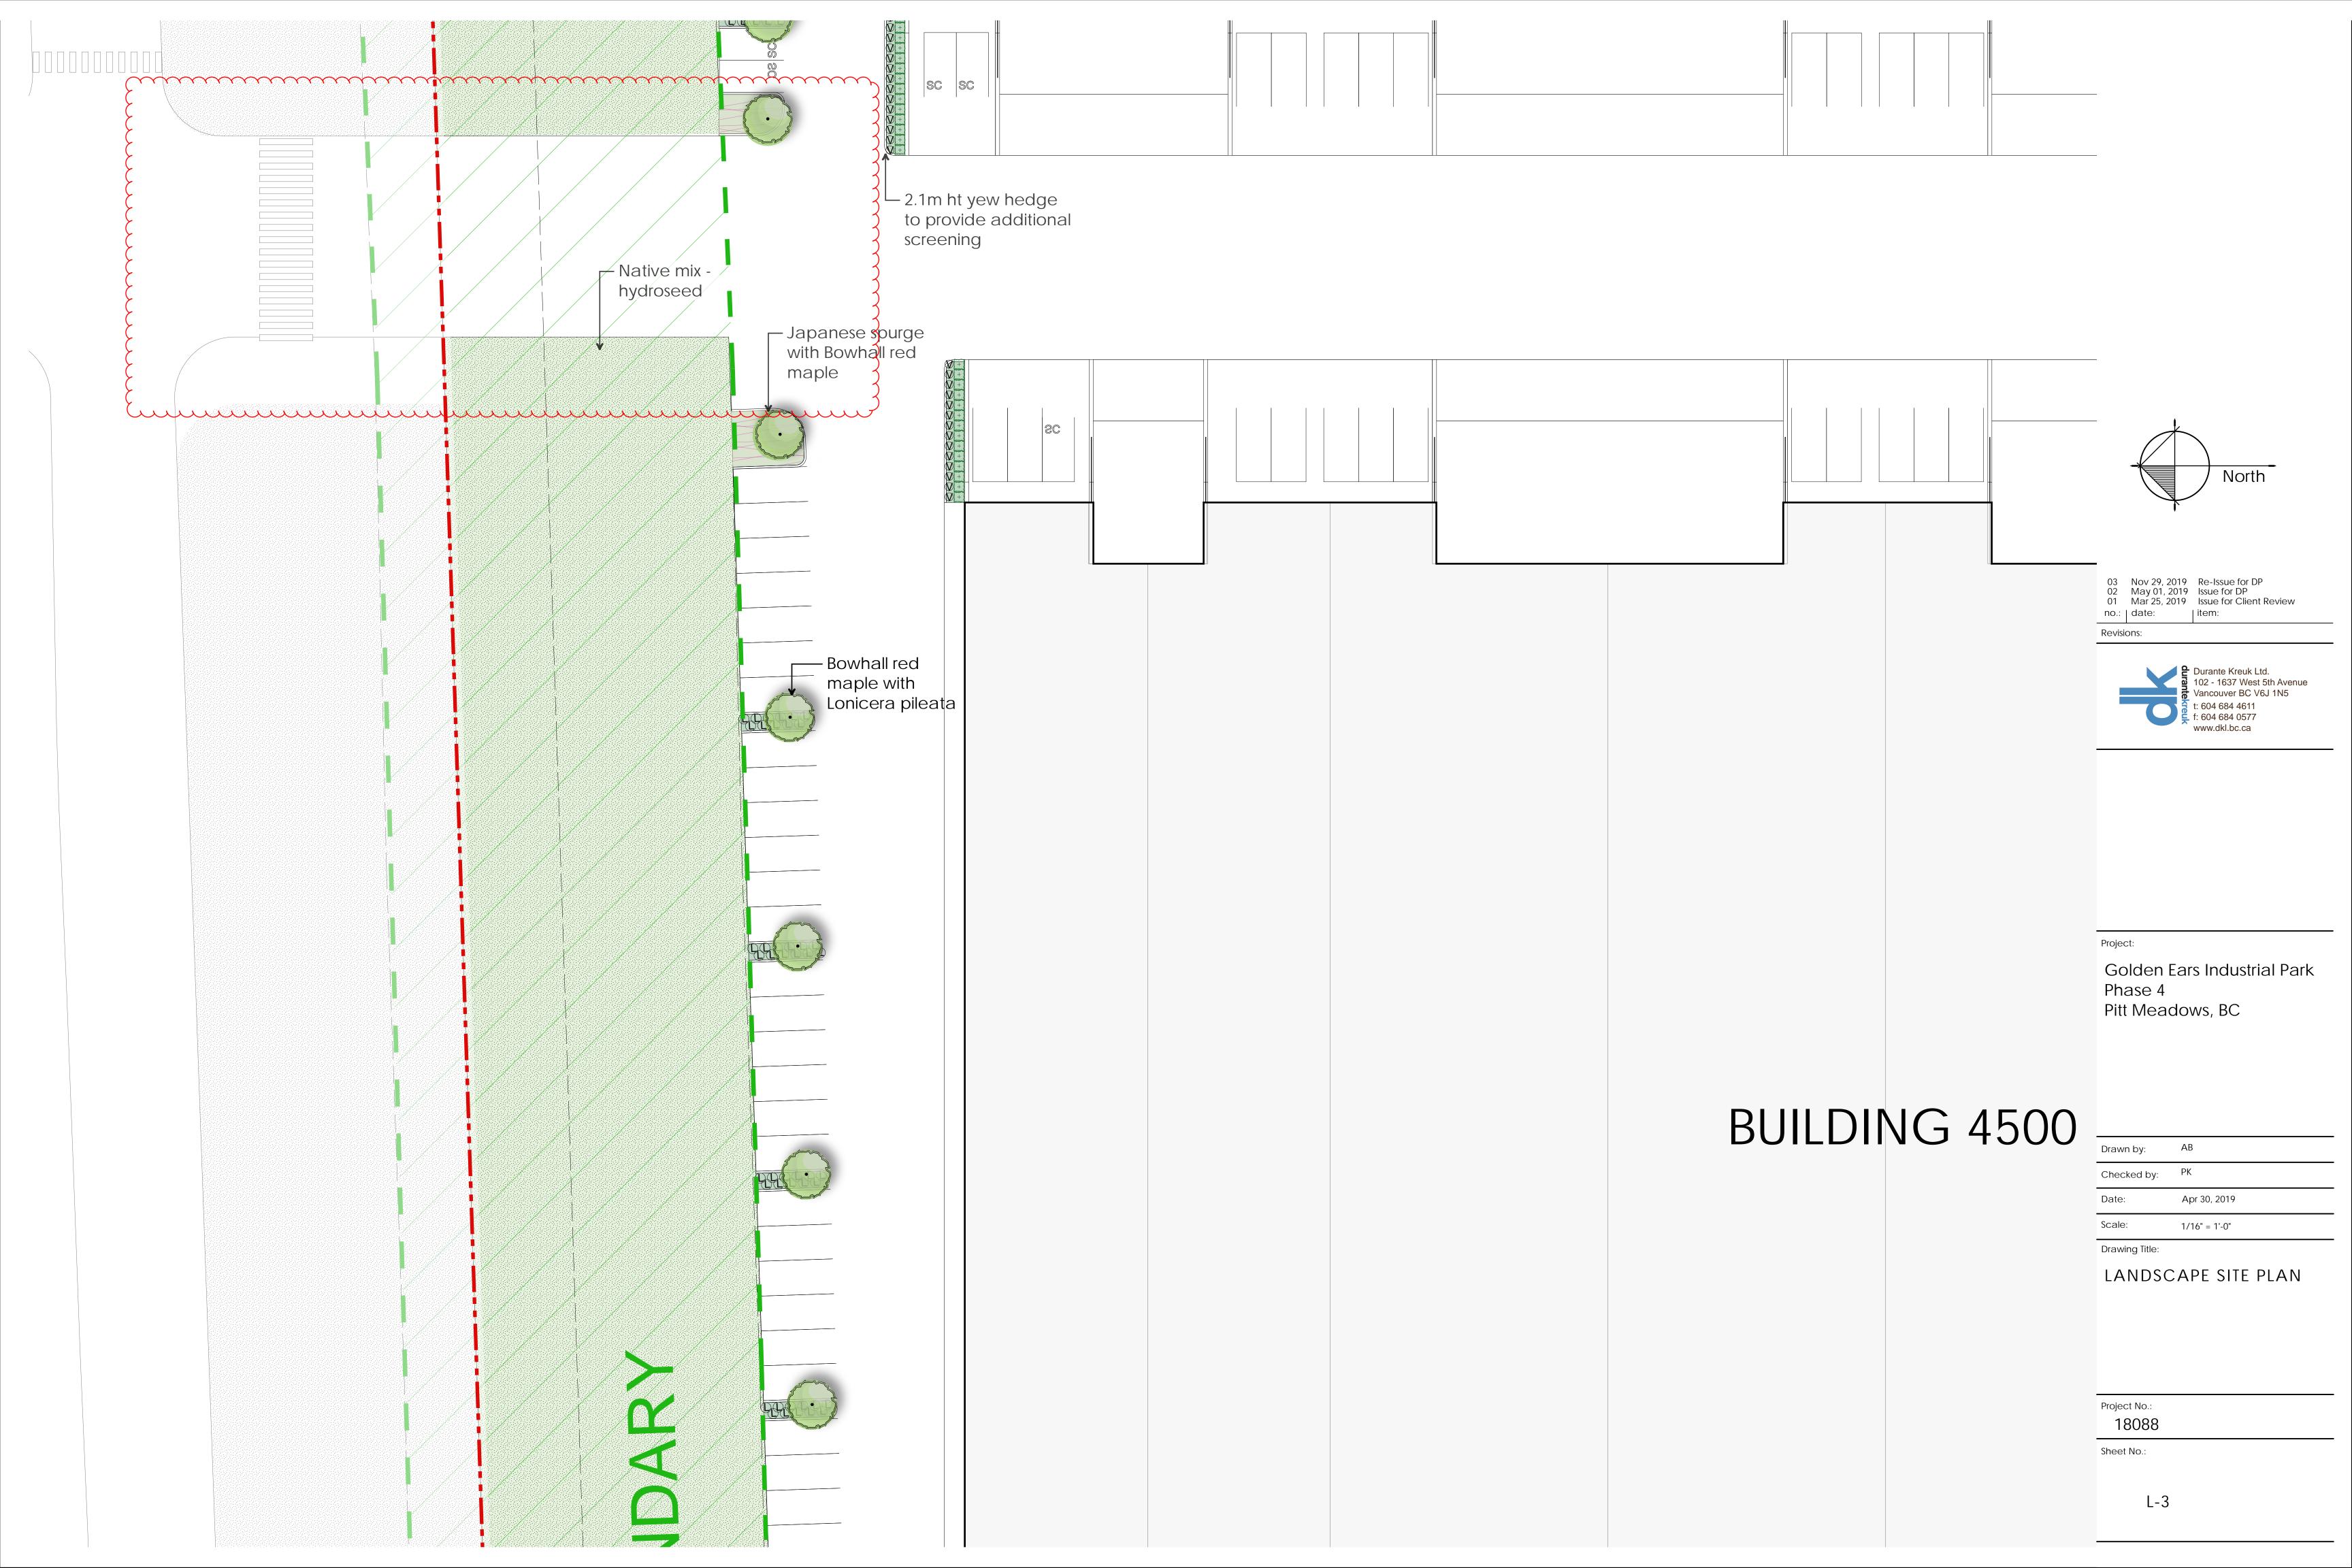
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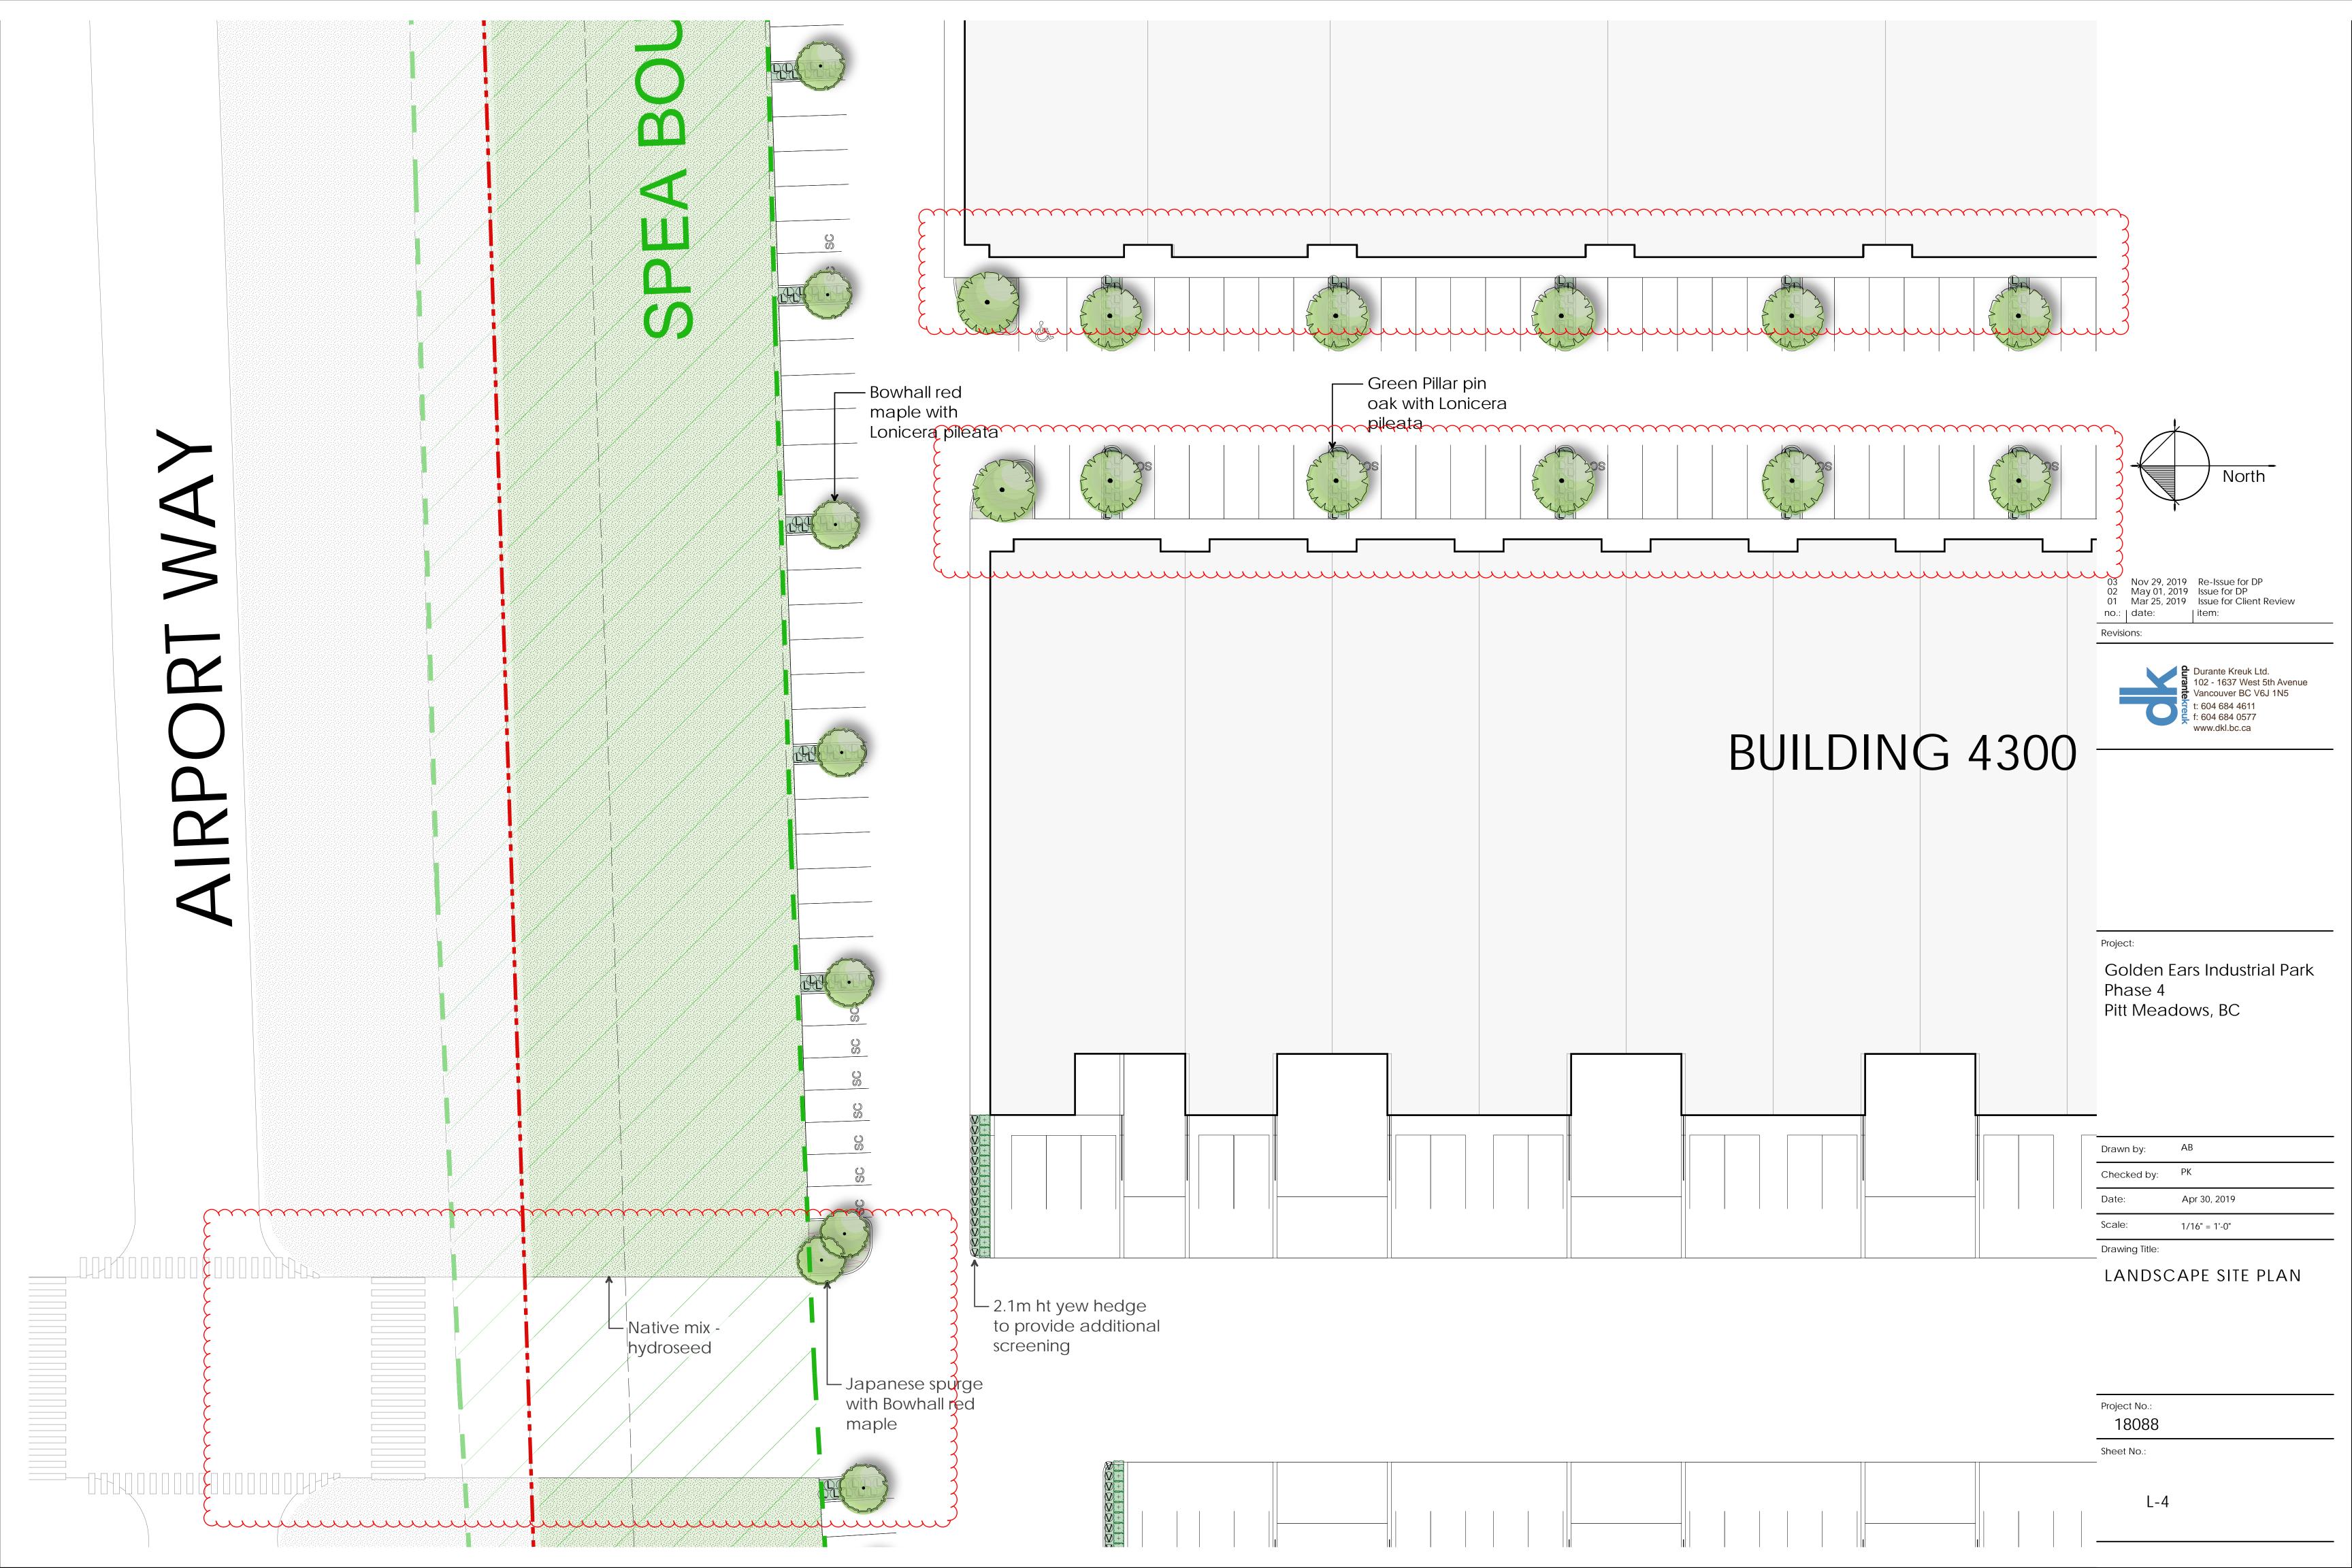
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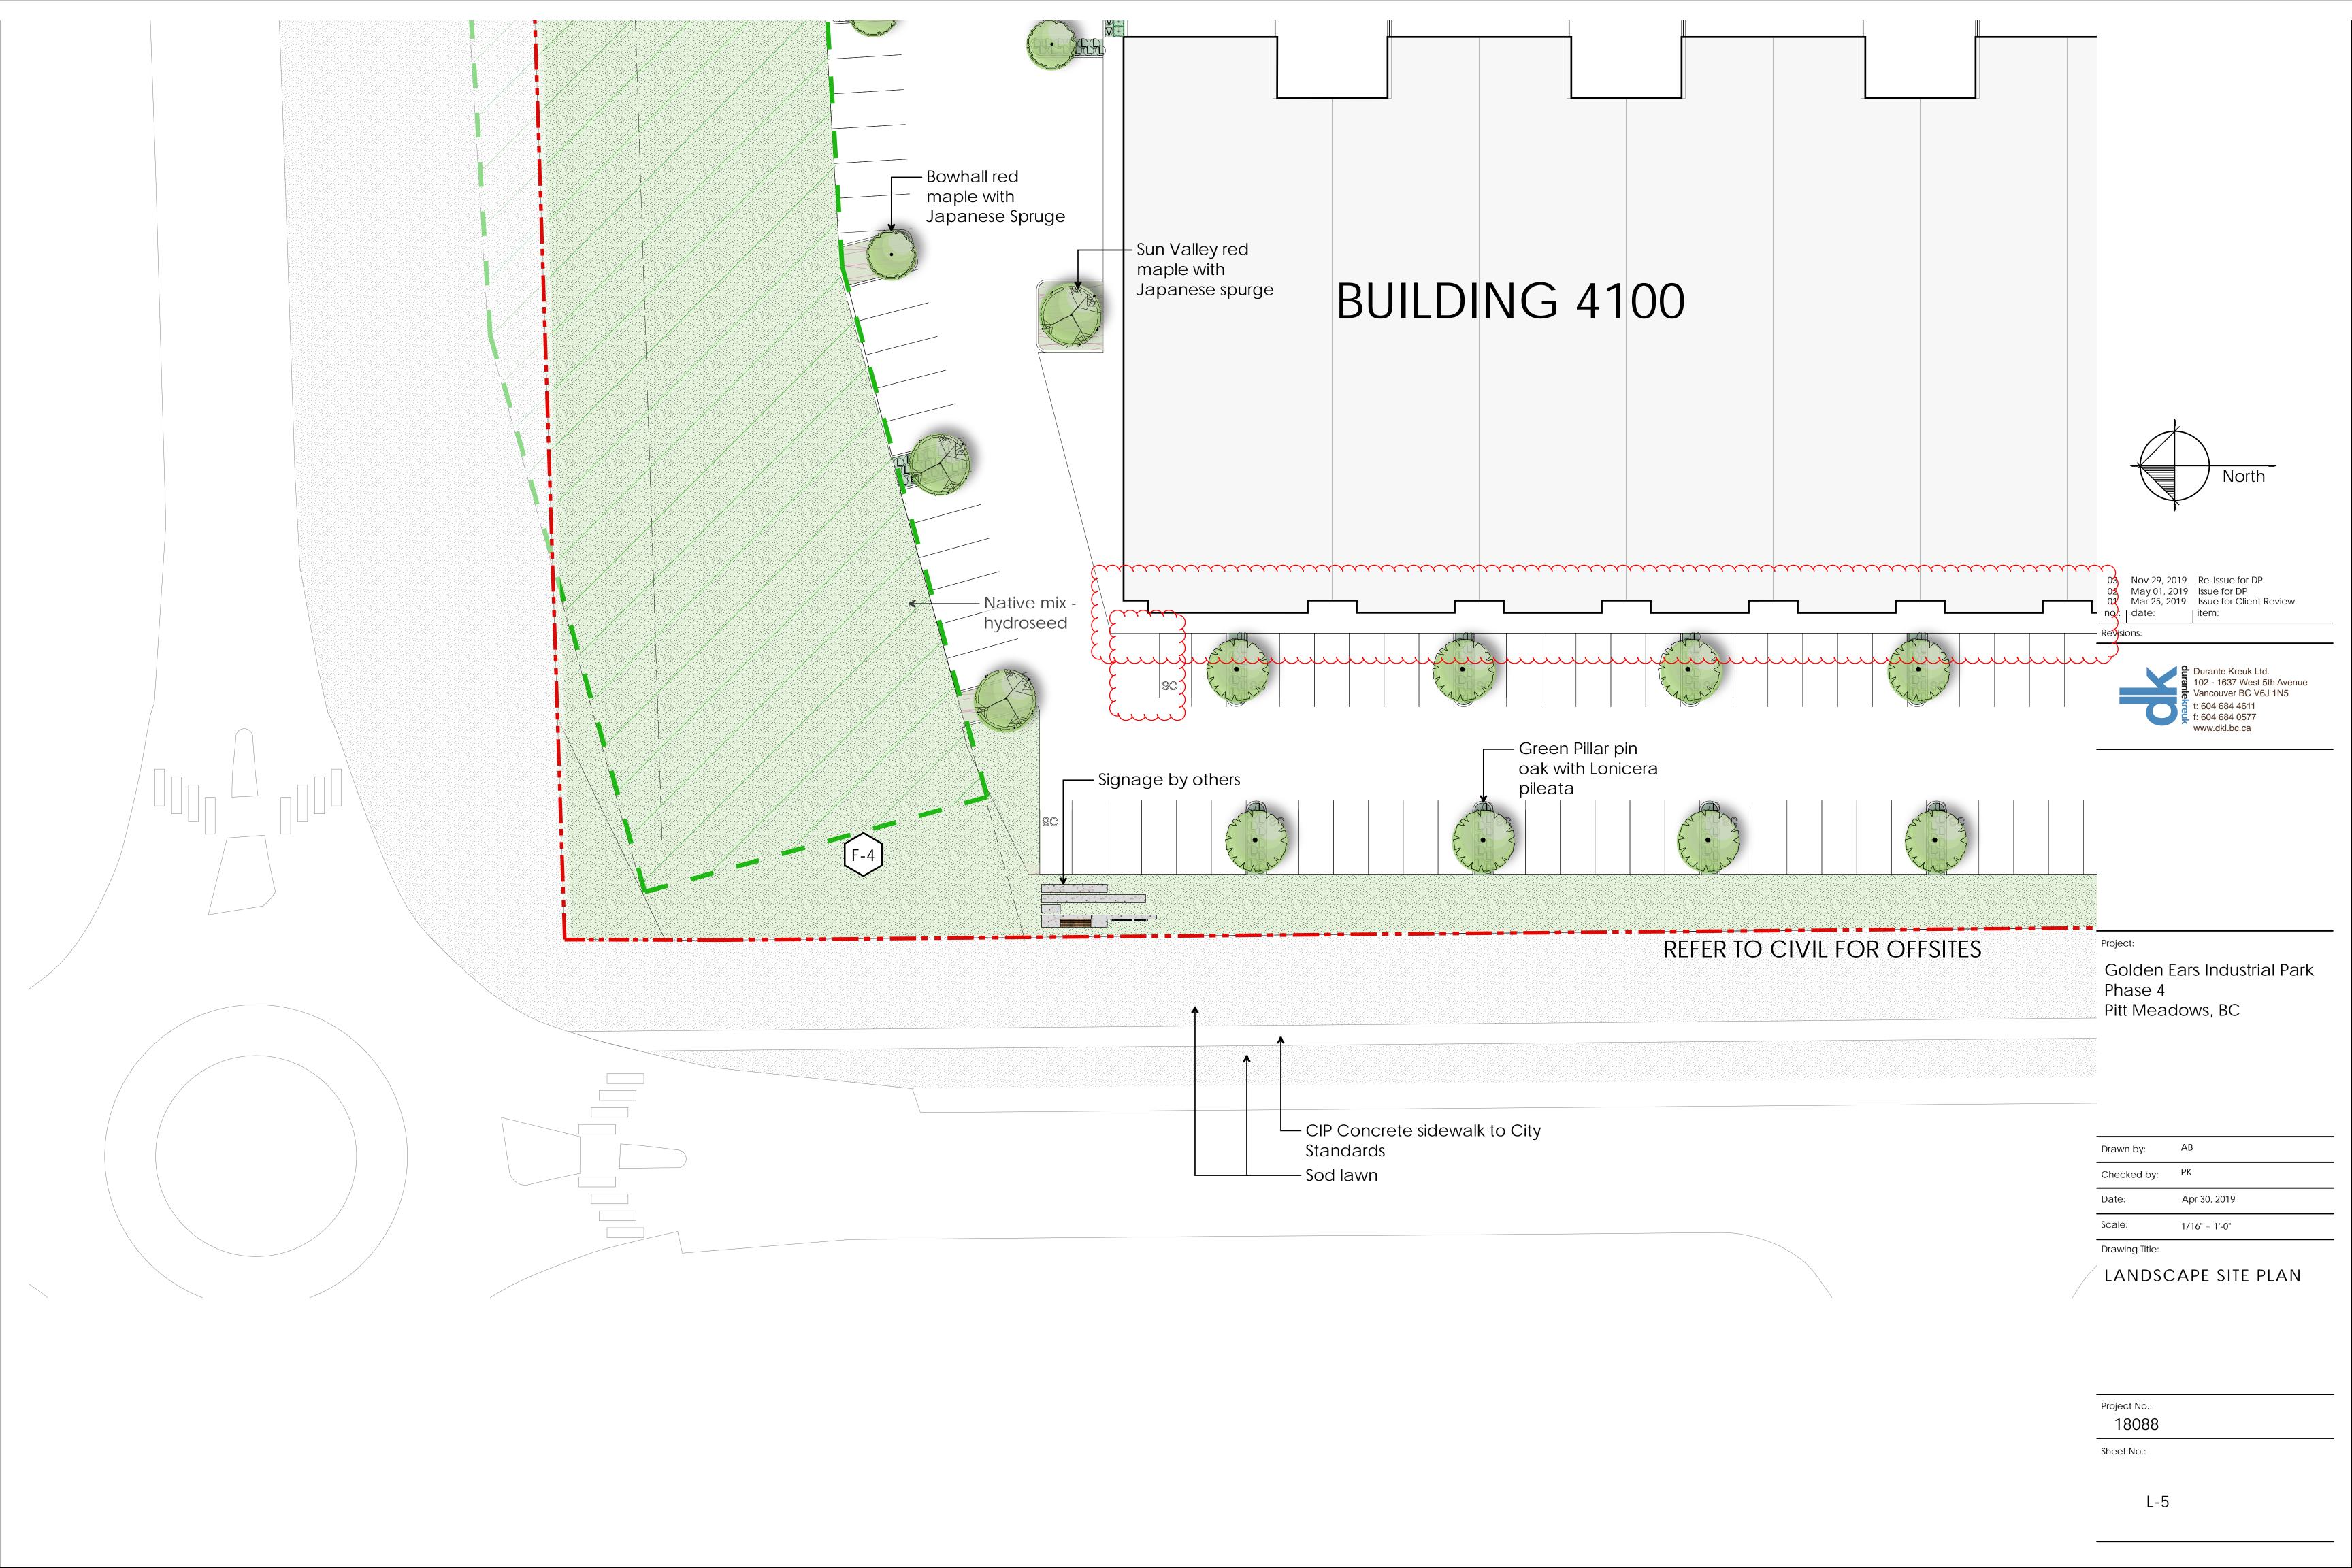
Project No.: 18088














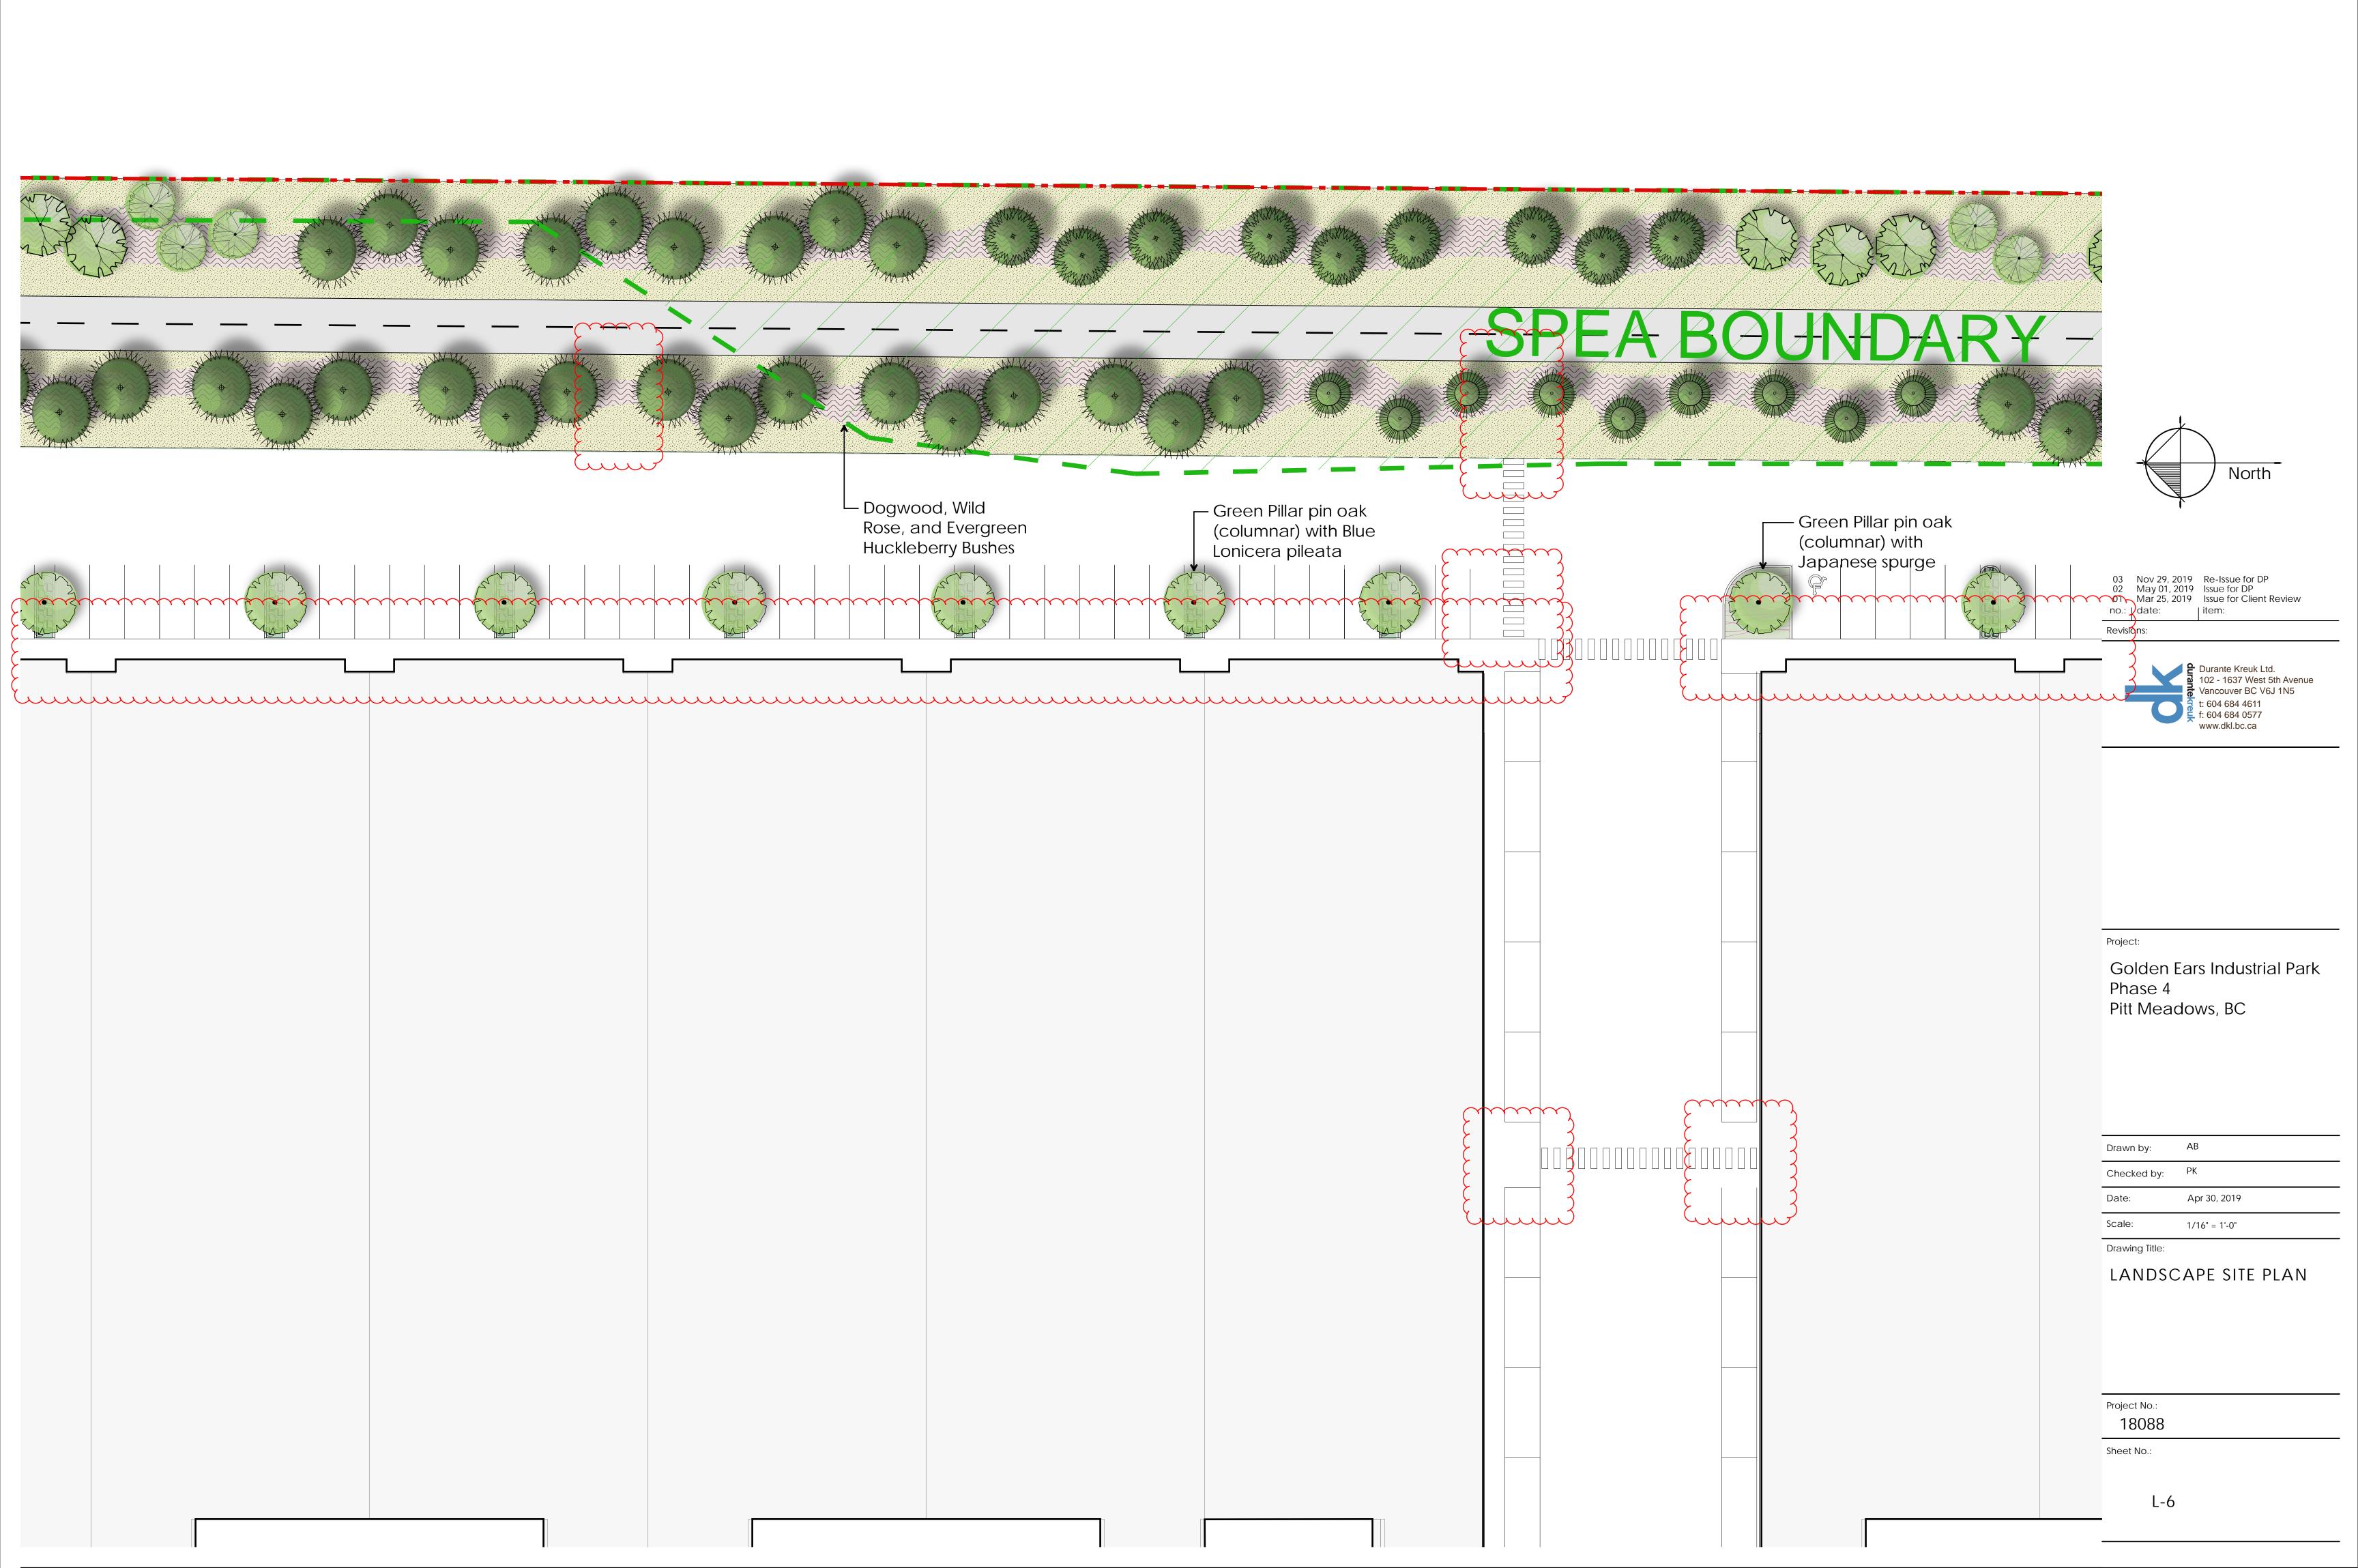


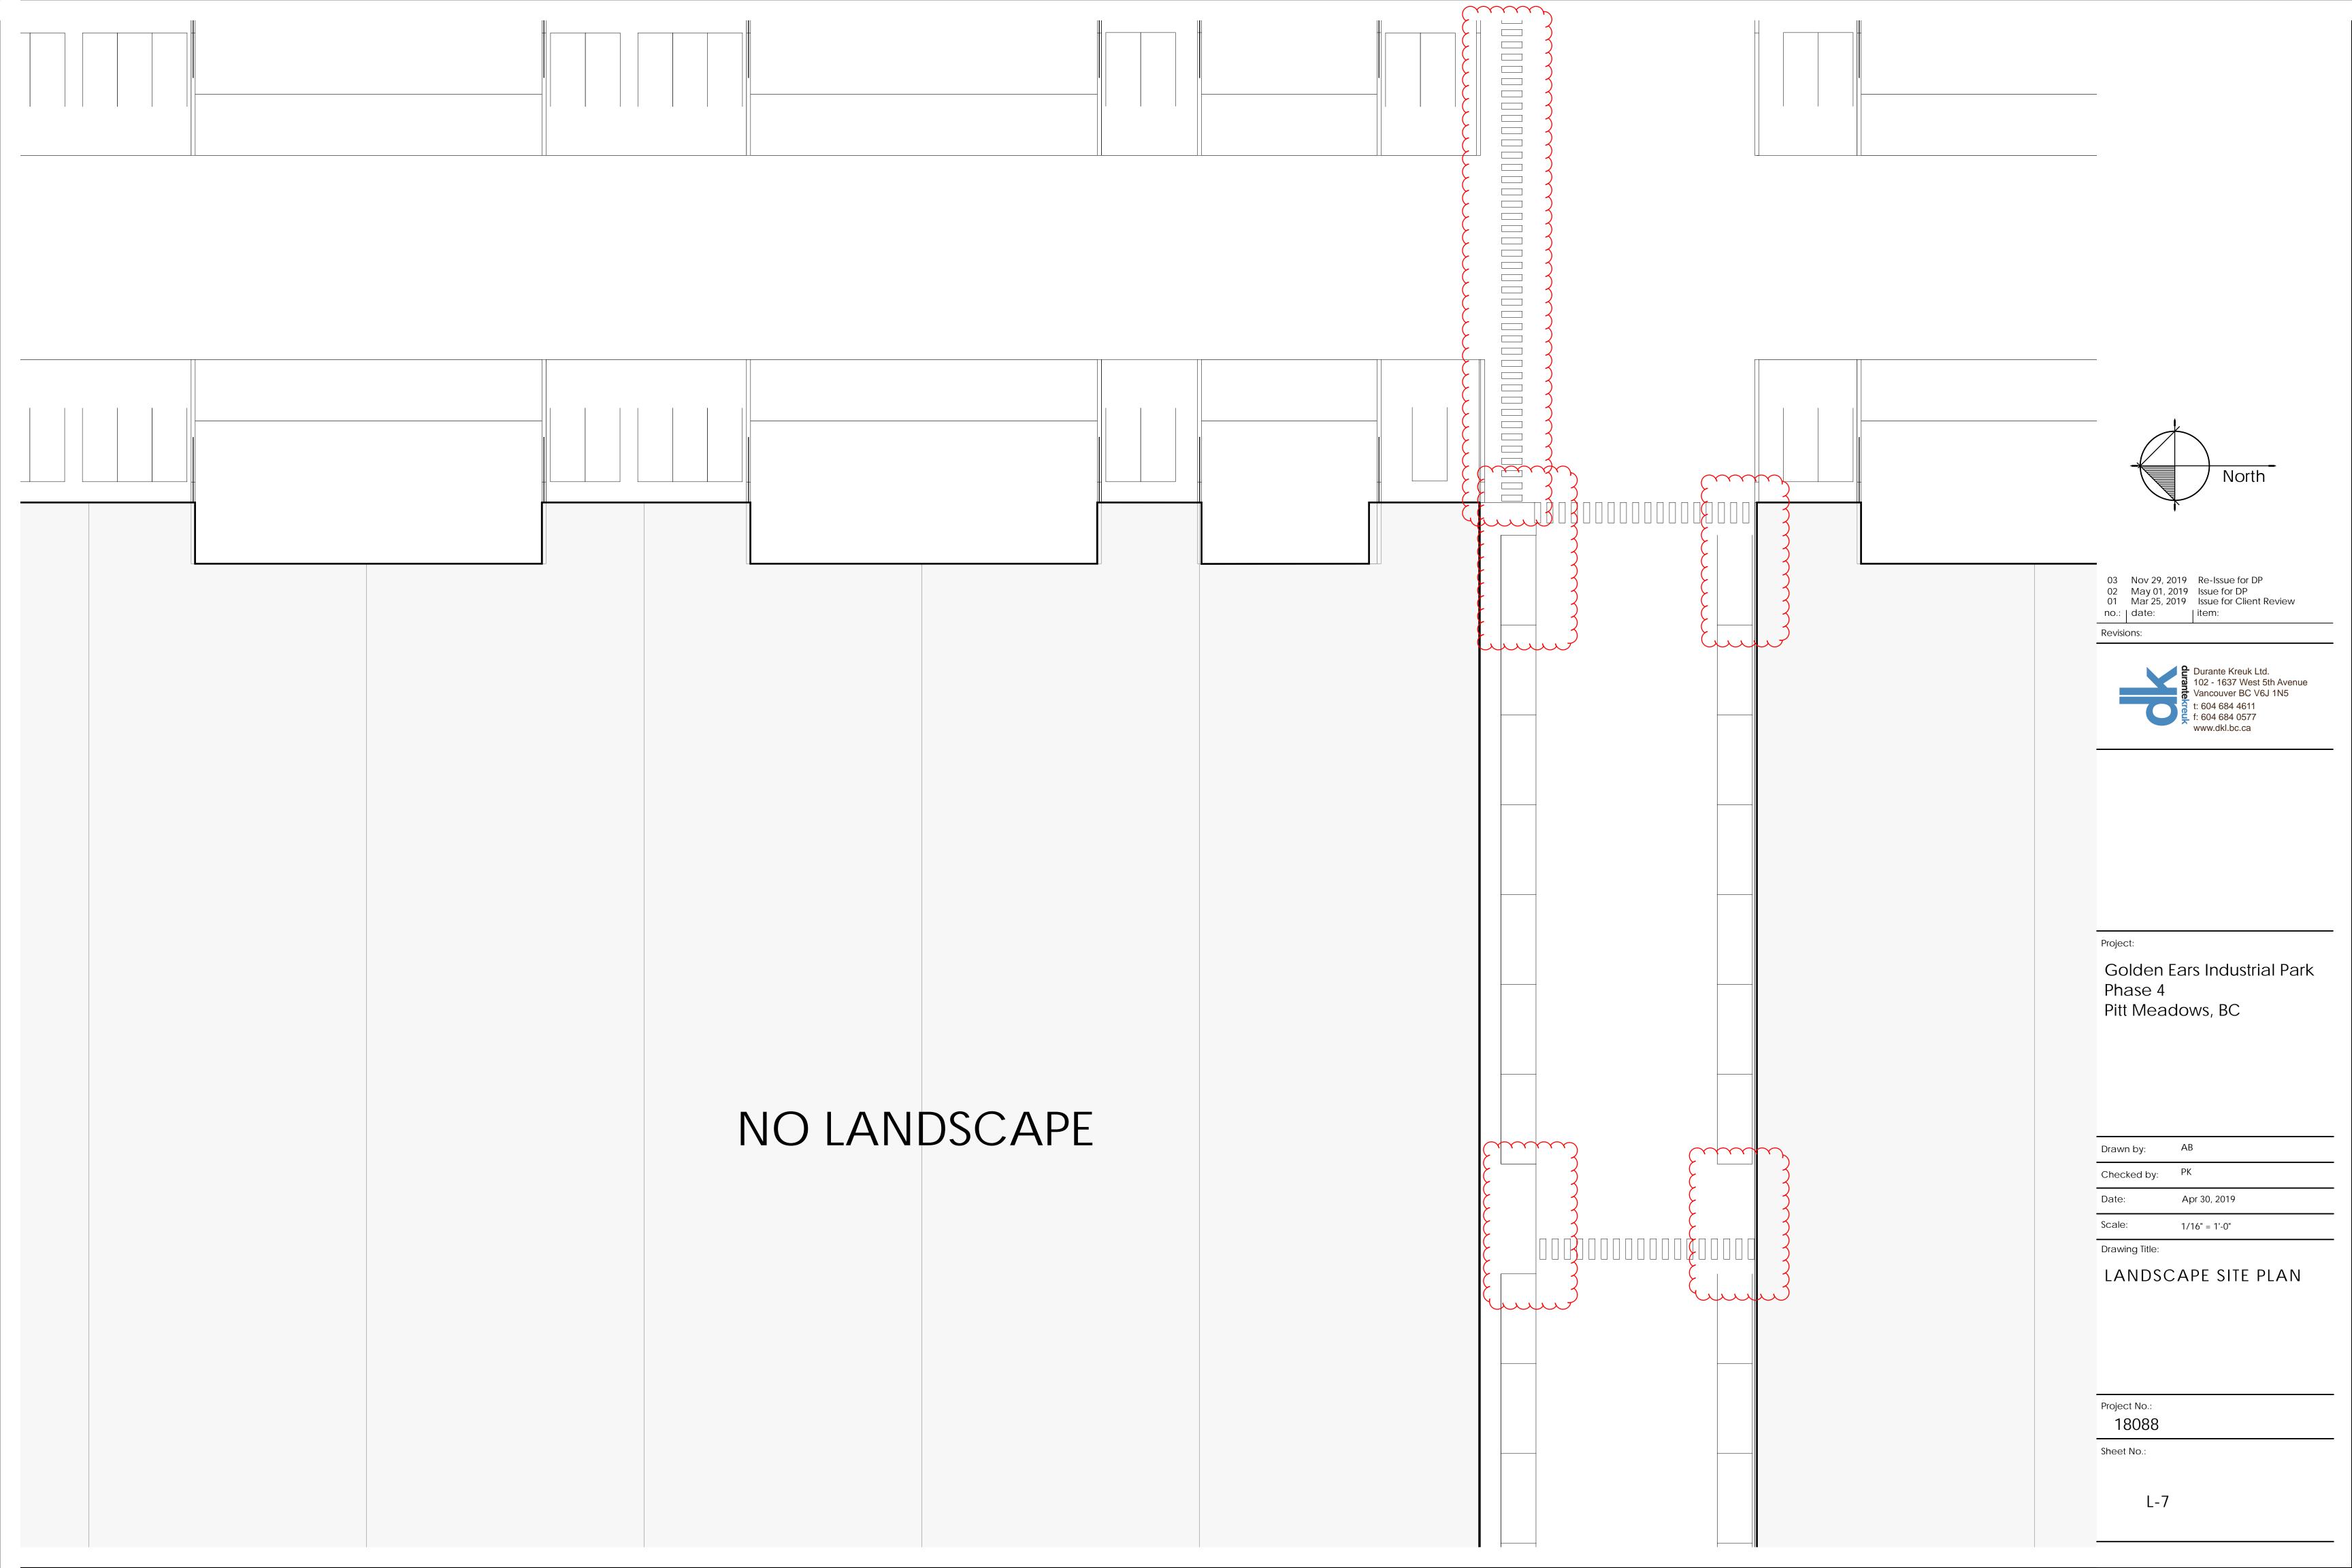




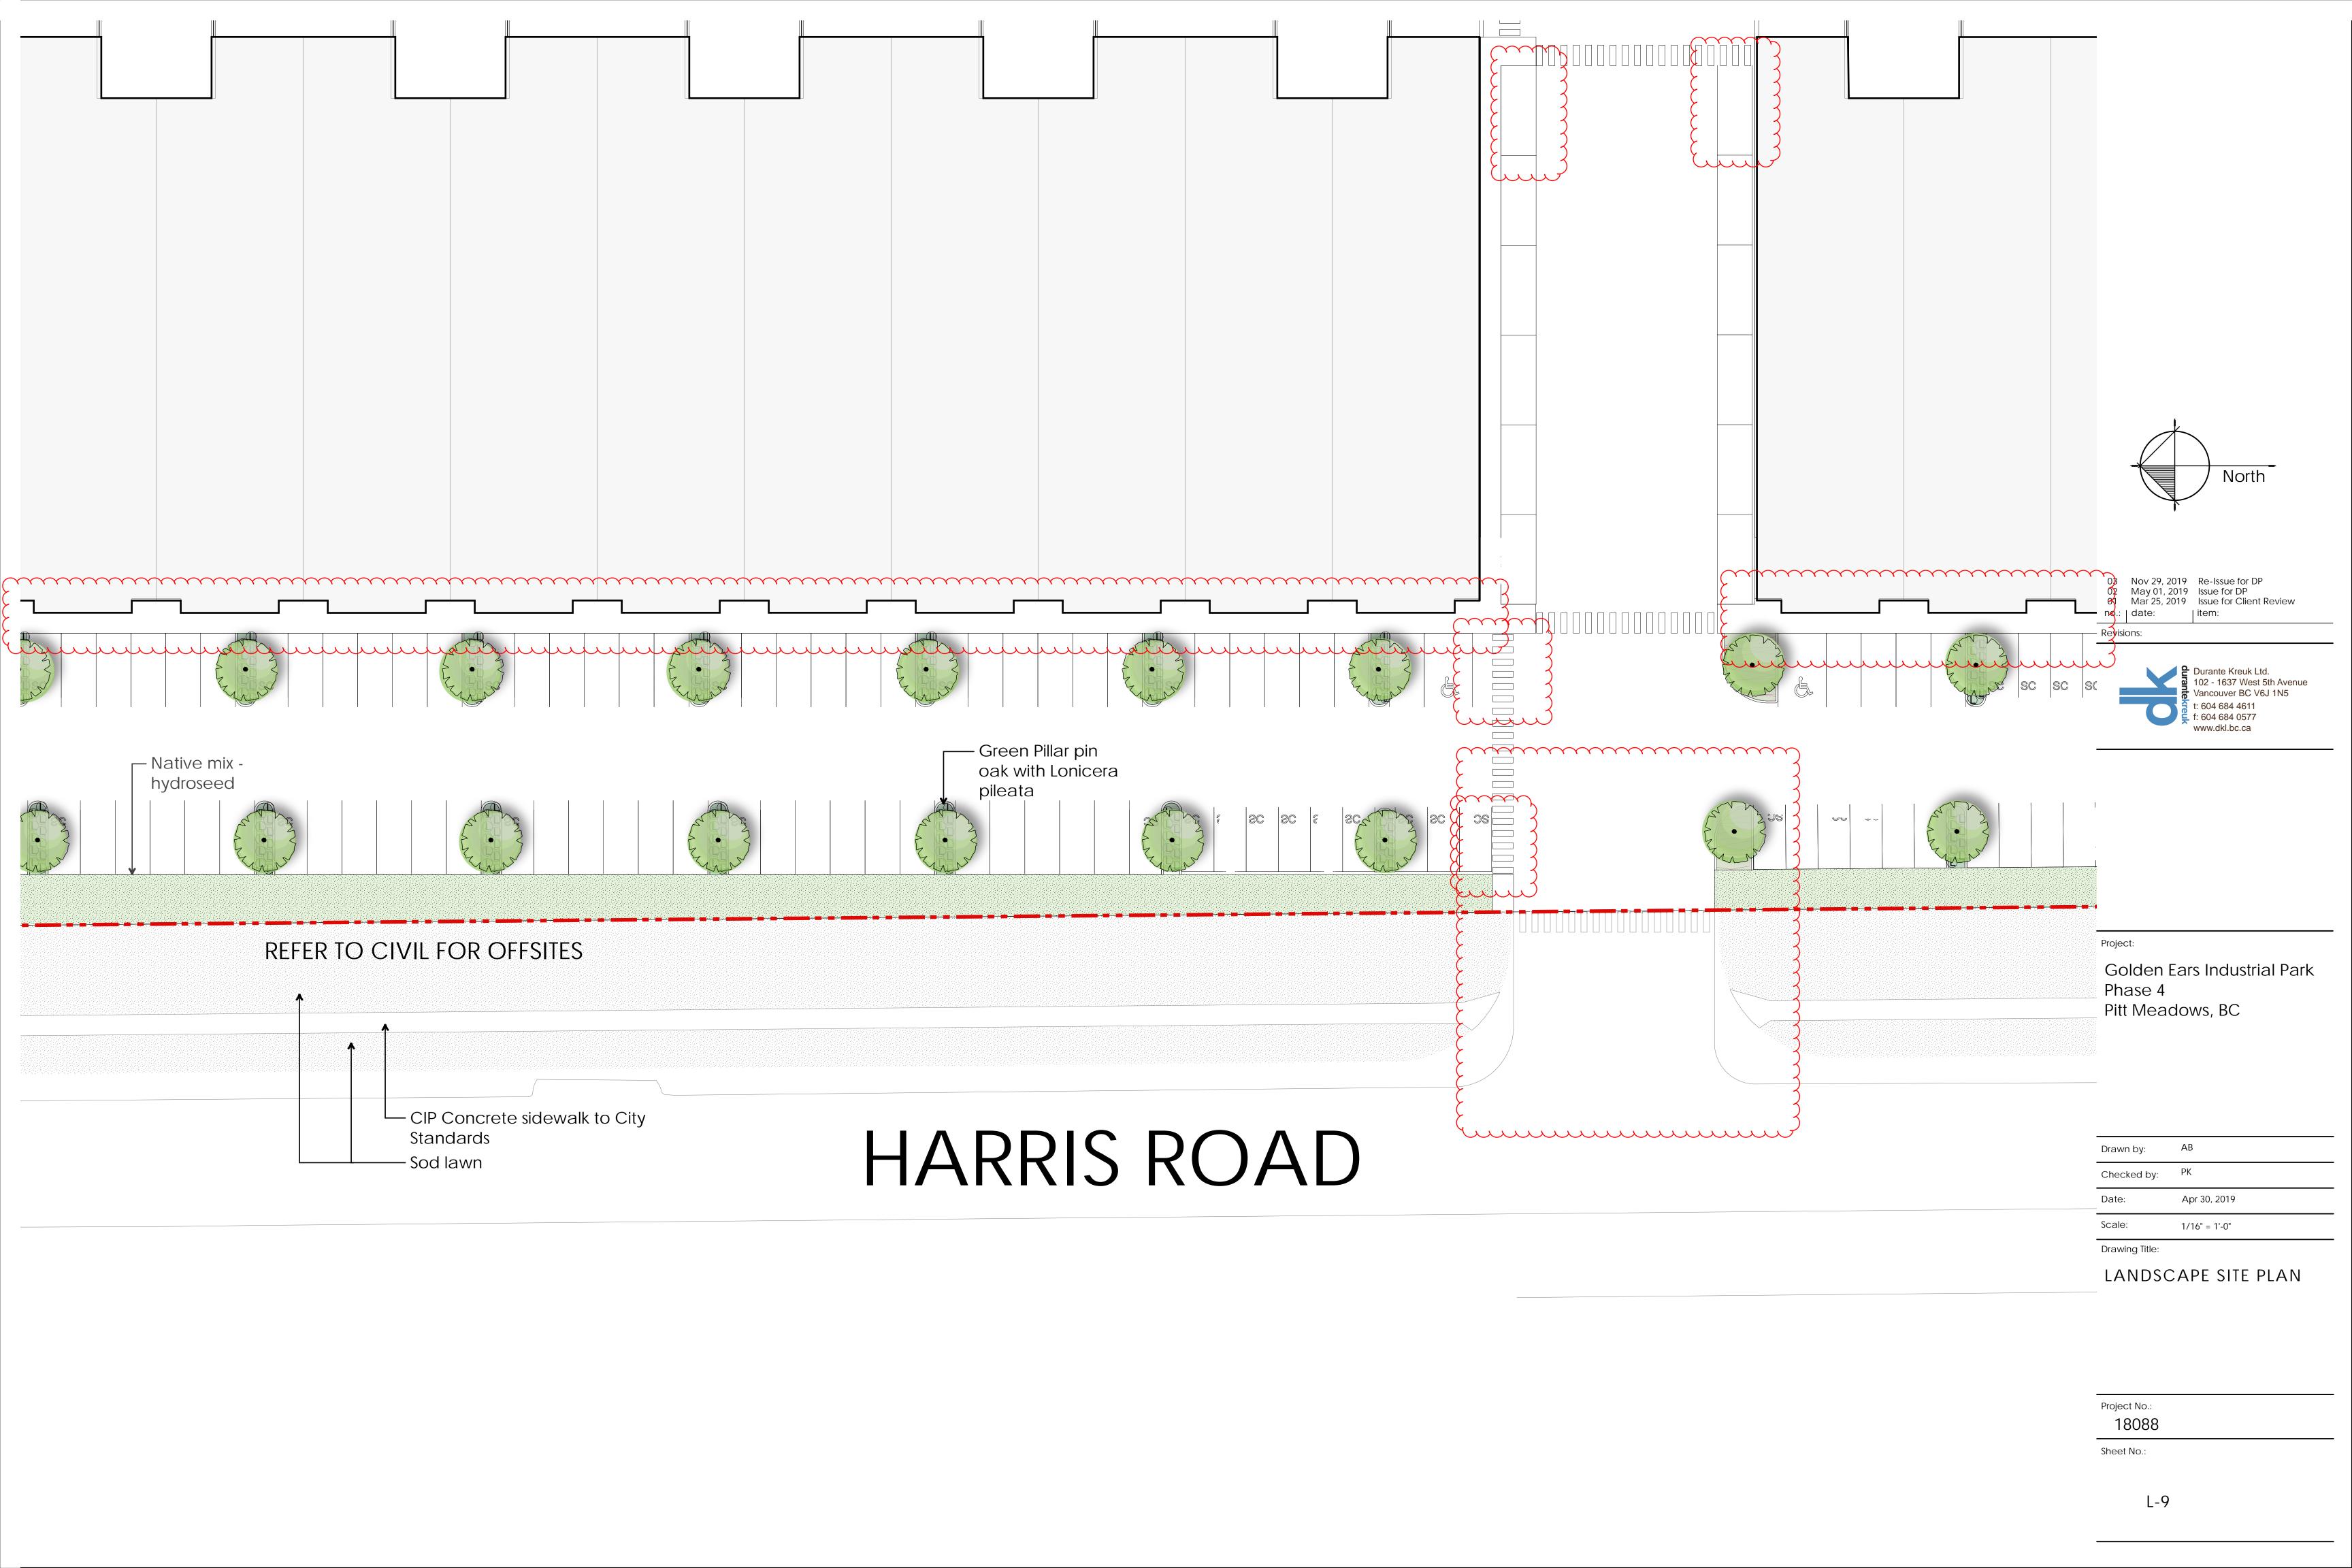




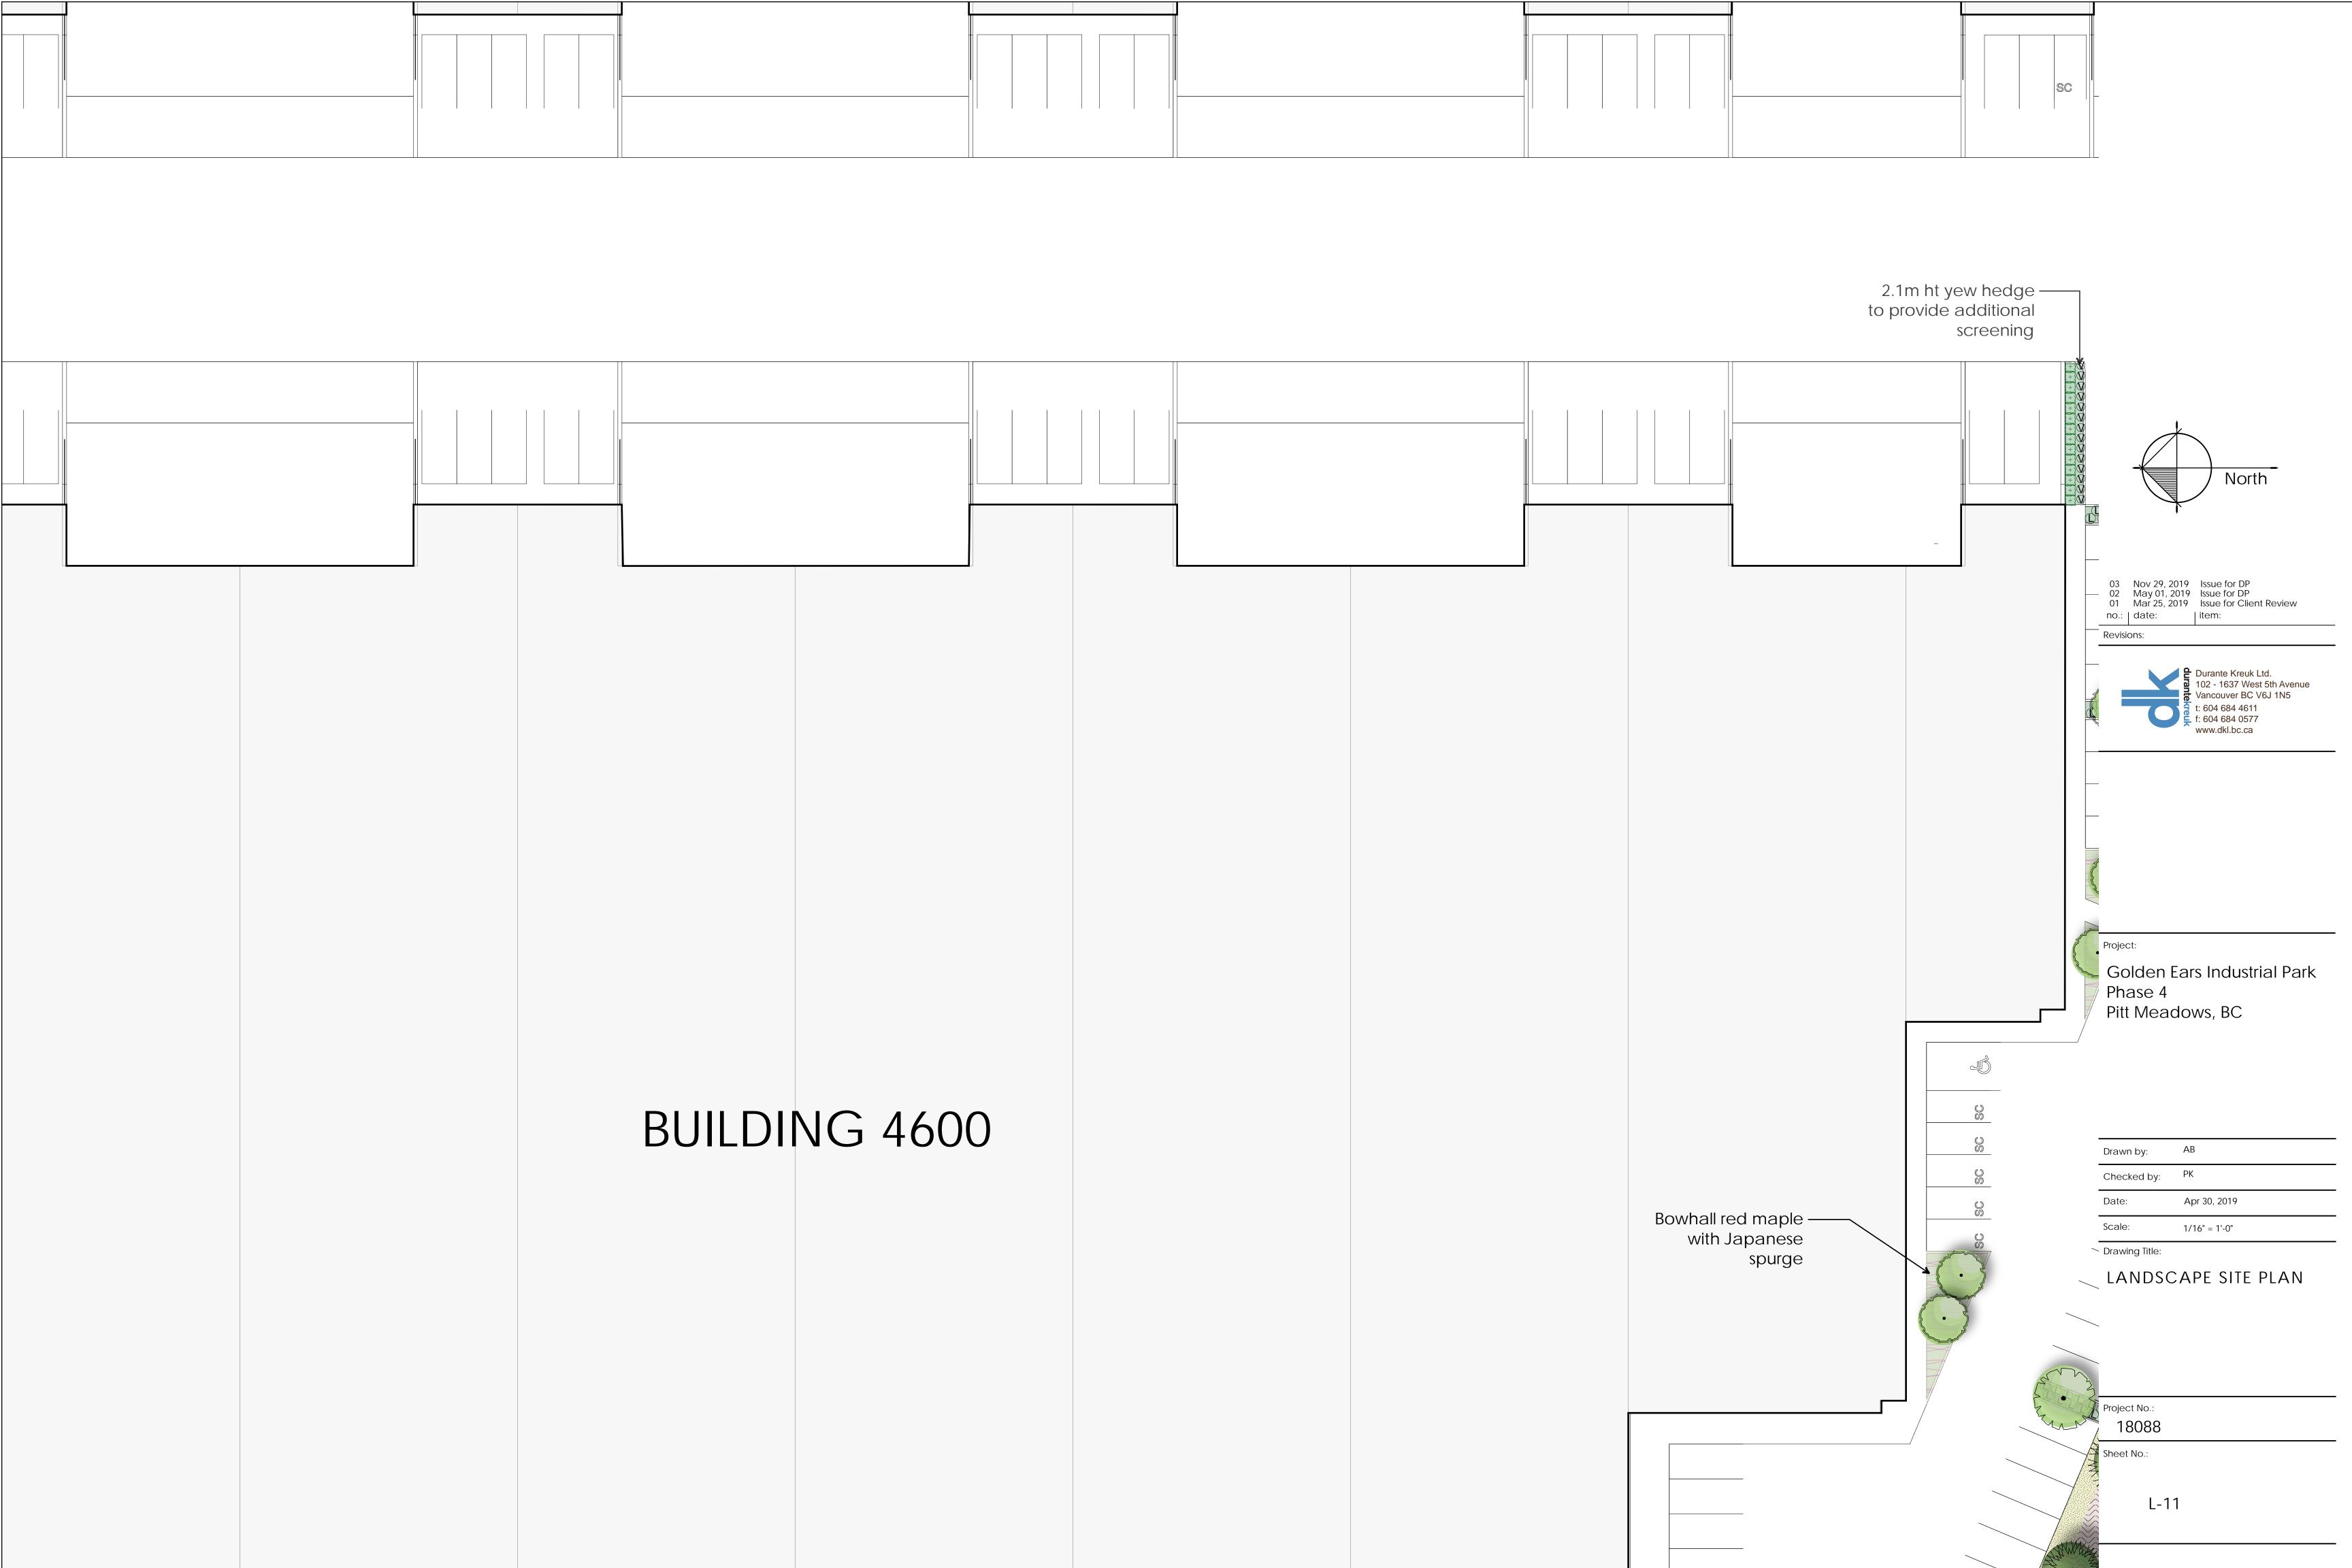



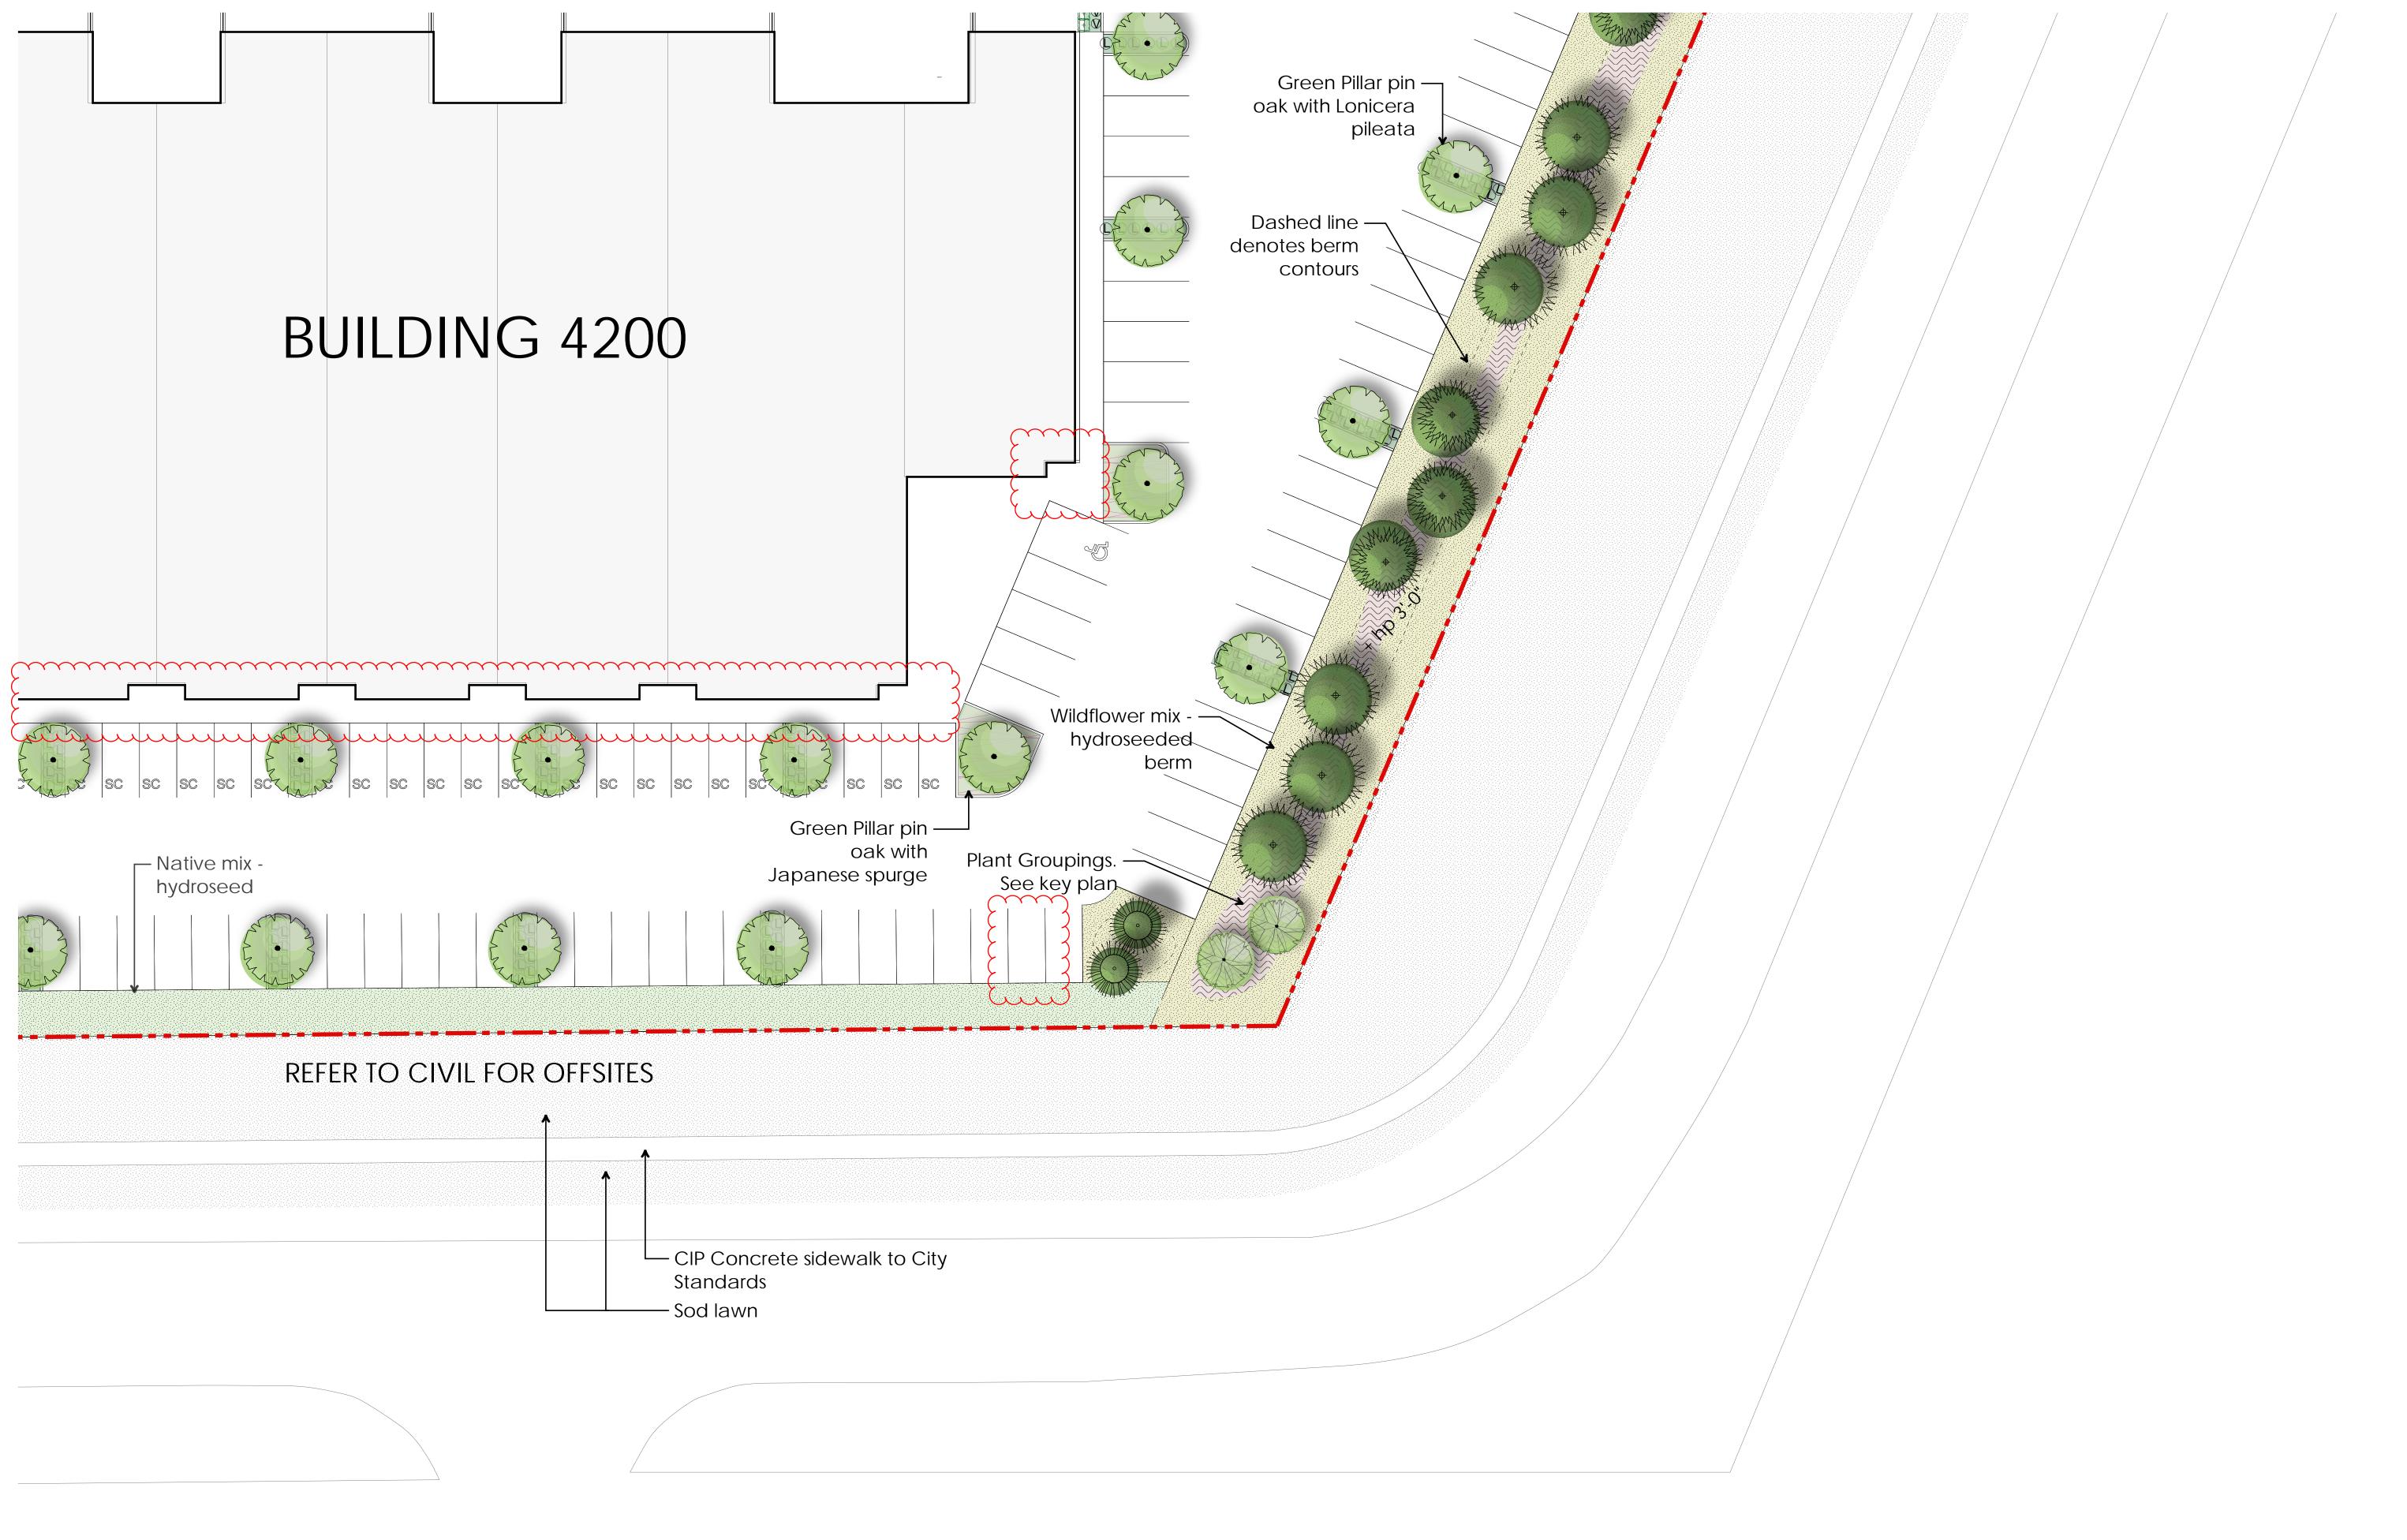

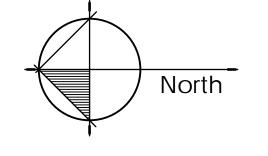

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Golden Ears Industrial Park
Phase 4

Pitt Meadows, BC

Drawn by: AB

Checked by: PK

Date: Apr 30, 2019

Scale: 1/16" = 1'-0"

Drawing Title:


LANDSCAPE SITE PLAN

Project No.: 18088

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Sheet No.:



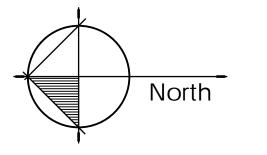

03 Nov 29, 2019 Re-Issue for DP 02 May 01, 2019 Issue for DP 01 Mar 25, 2019 Issue for Client Review no.: | date: | item:

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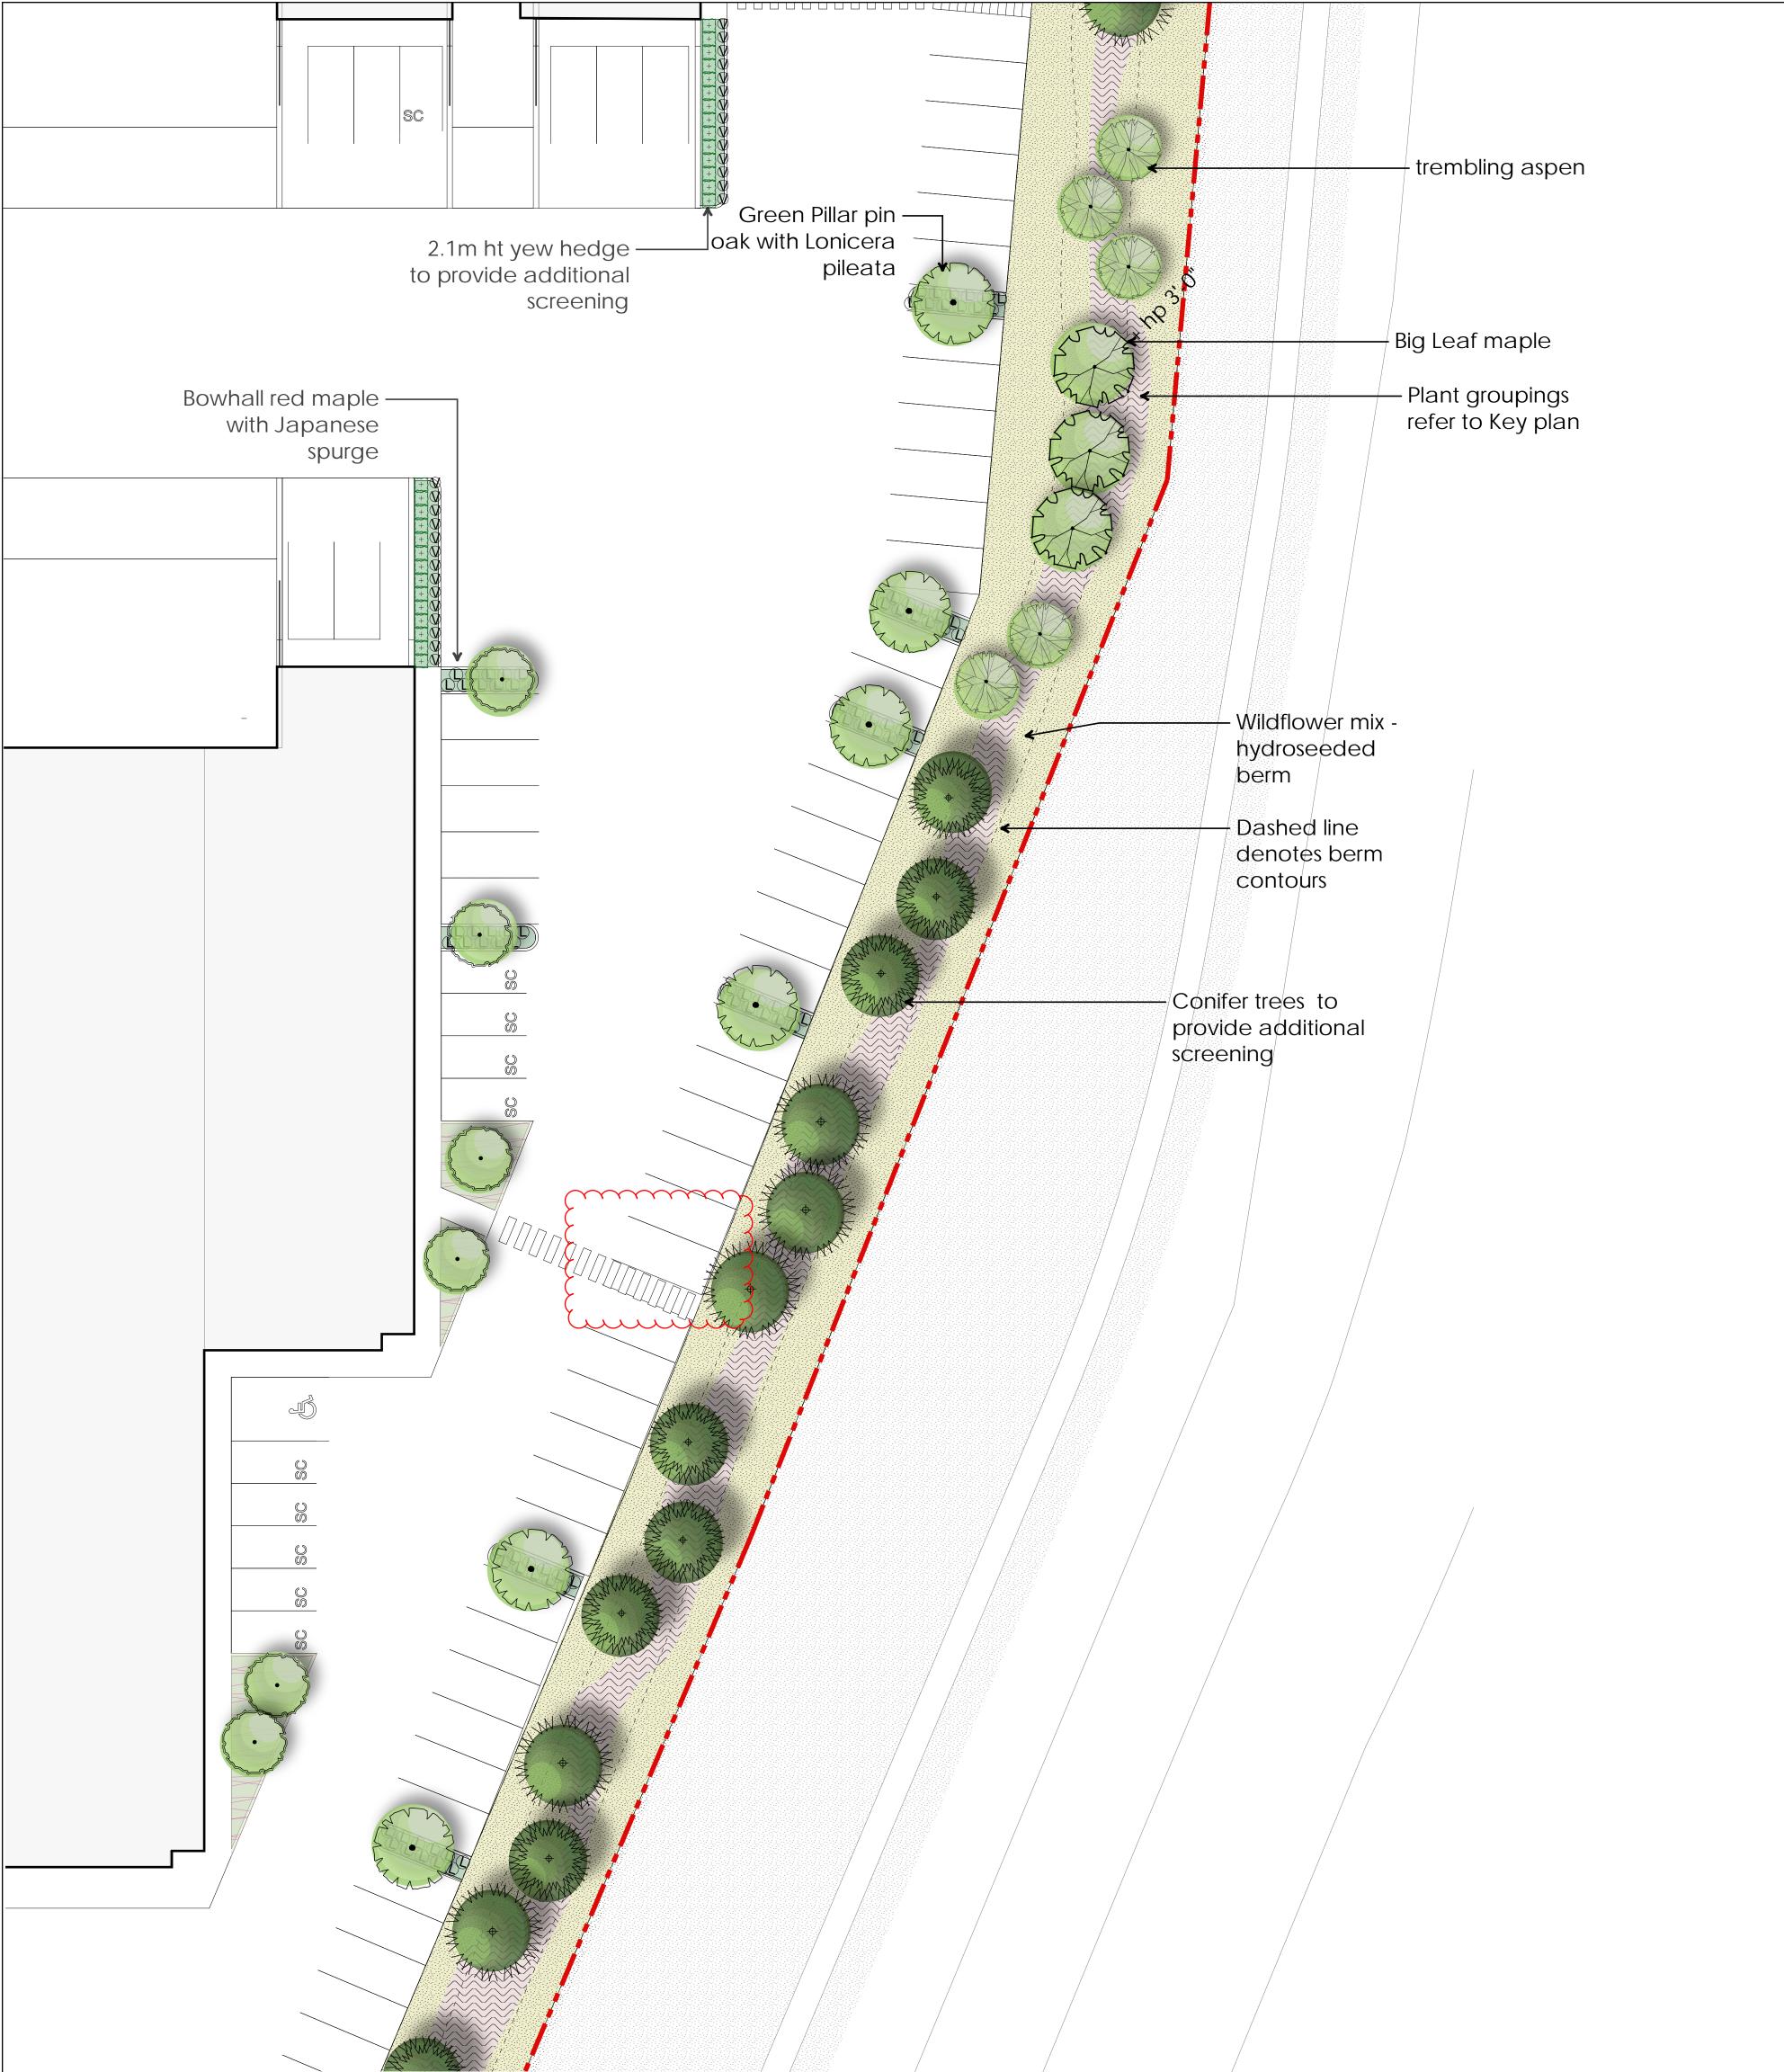
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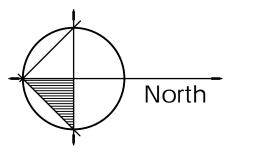
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LANDSCAPE SITE PLAN

Project No.: 18088

Sheet No.:





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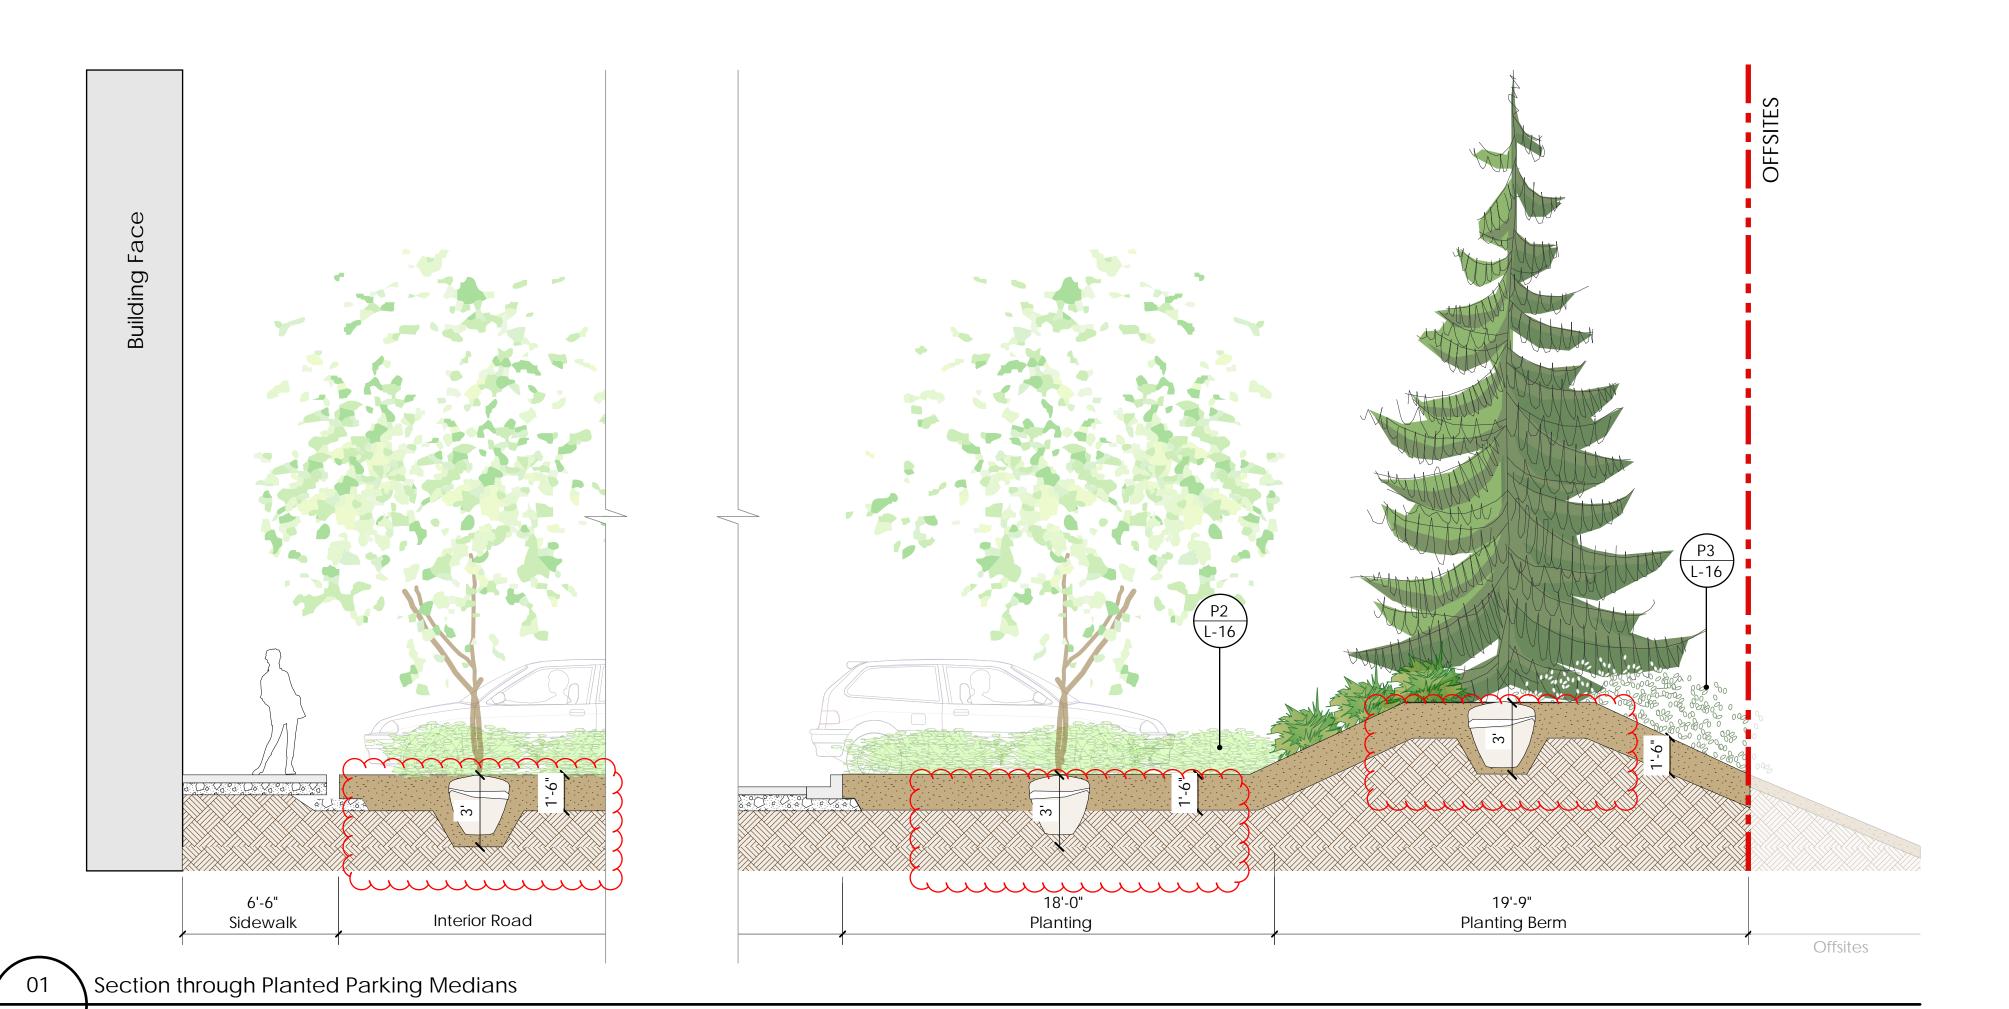
Durante Kreuk Ltd.
102 - 1637 West 5th Avenue
Vancouver BC V6J 1N5 t: 604 684 4611 f: 604 684 0577 www.dkl.bc.ca

Golden Ears Industrial Park Phase 4 Pitt Meadows, BC

Drawn by: AB Checked by: PK Apr 30, 2019 1/16" = 1'-0" Scale: Drawing Title:

LANDSCAPE SITE PLAN

Project No.: 18088




Notewalls Inverter load Penting Plenting Plenting

Section through Drive aisle and Berm

L-13 / 1/4"=1'-0"



P1 Precedent Image: Grove of Trembling Aspen

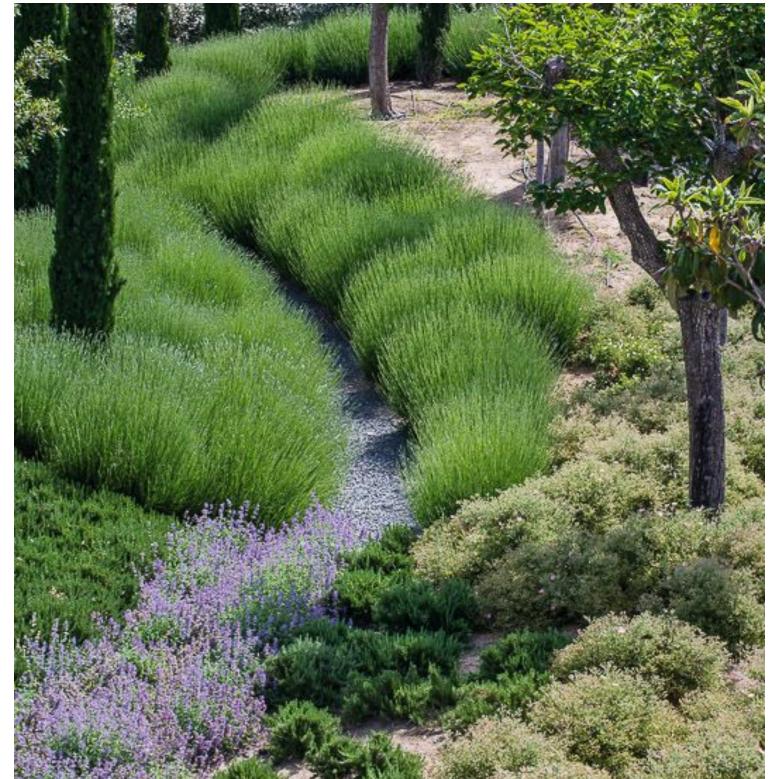

P2 Precedent Image: Planted Berm with Native Flowers and Tree Groupings



P3 Precedent Image: Planted Berm with Native Flowers and Tree Groupings

Offsites

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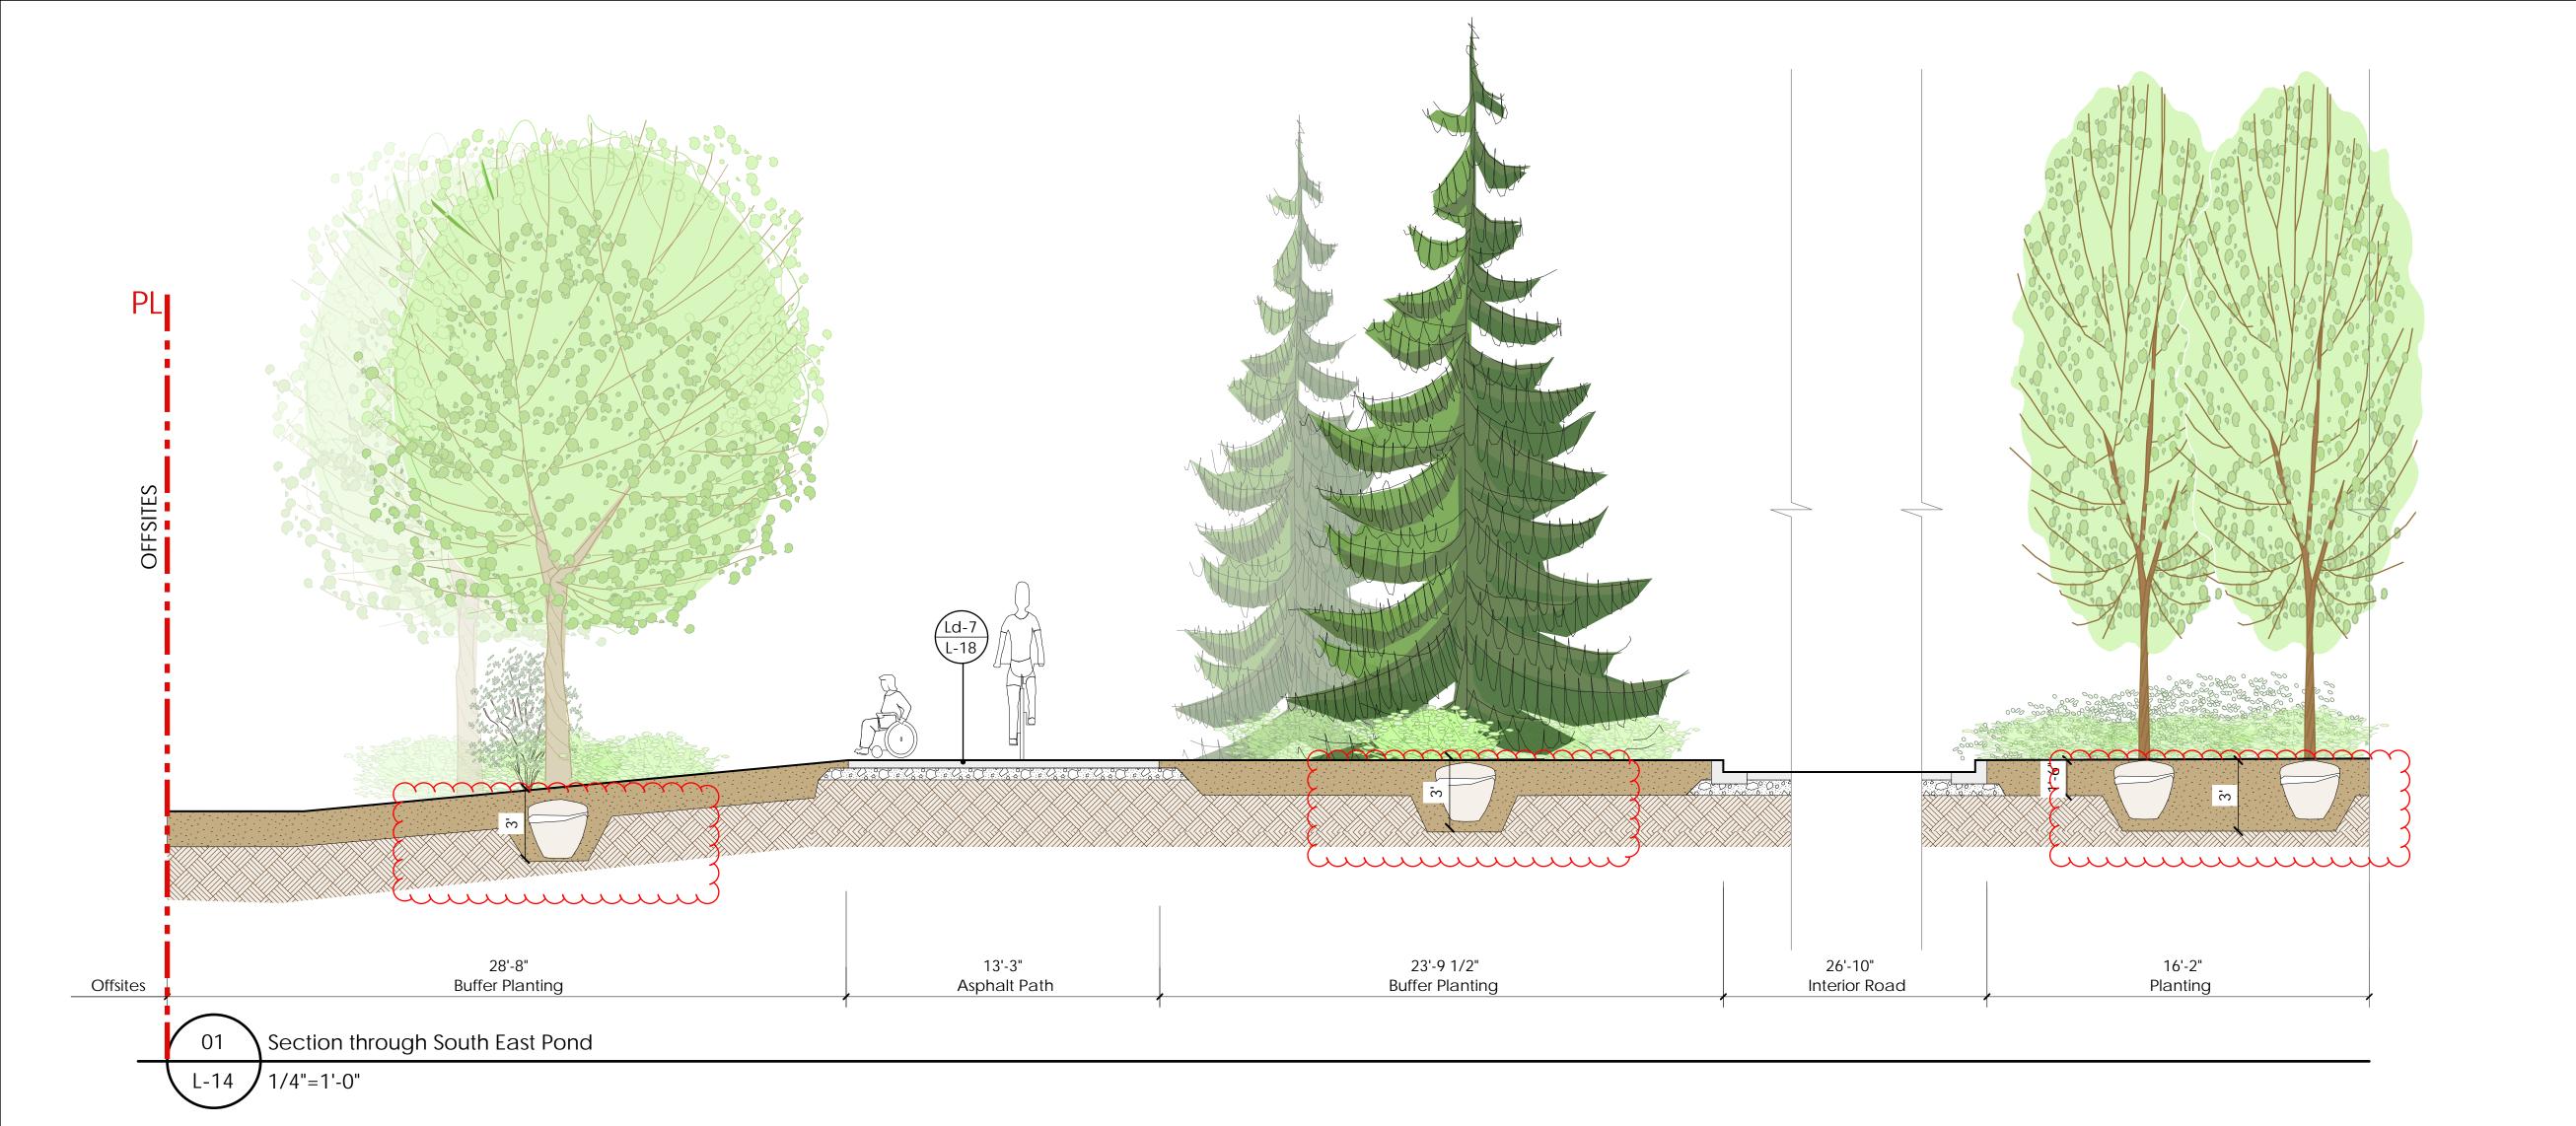
Golden Ears Industrial Park Phase 4, Pitt Meadows, BC


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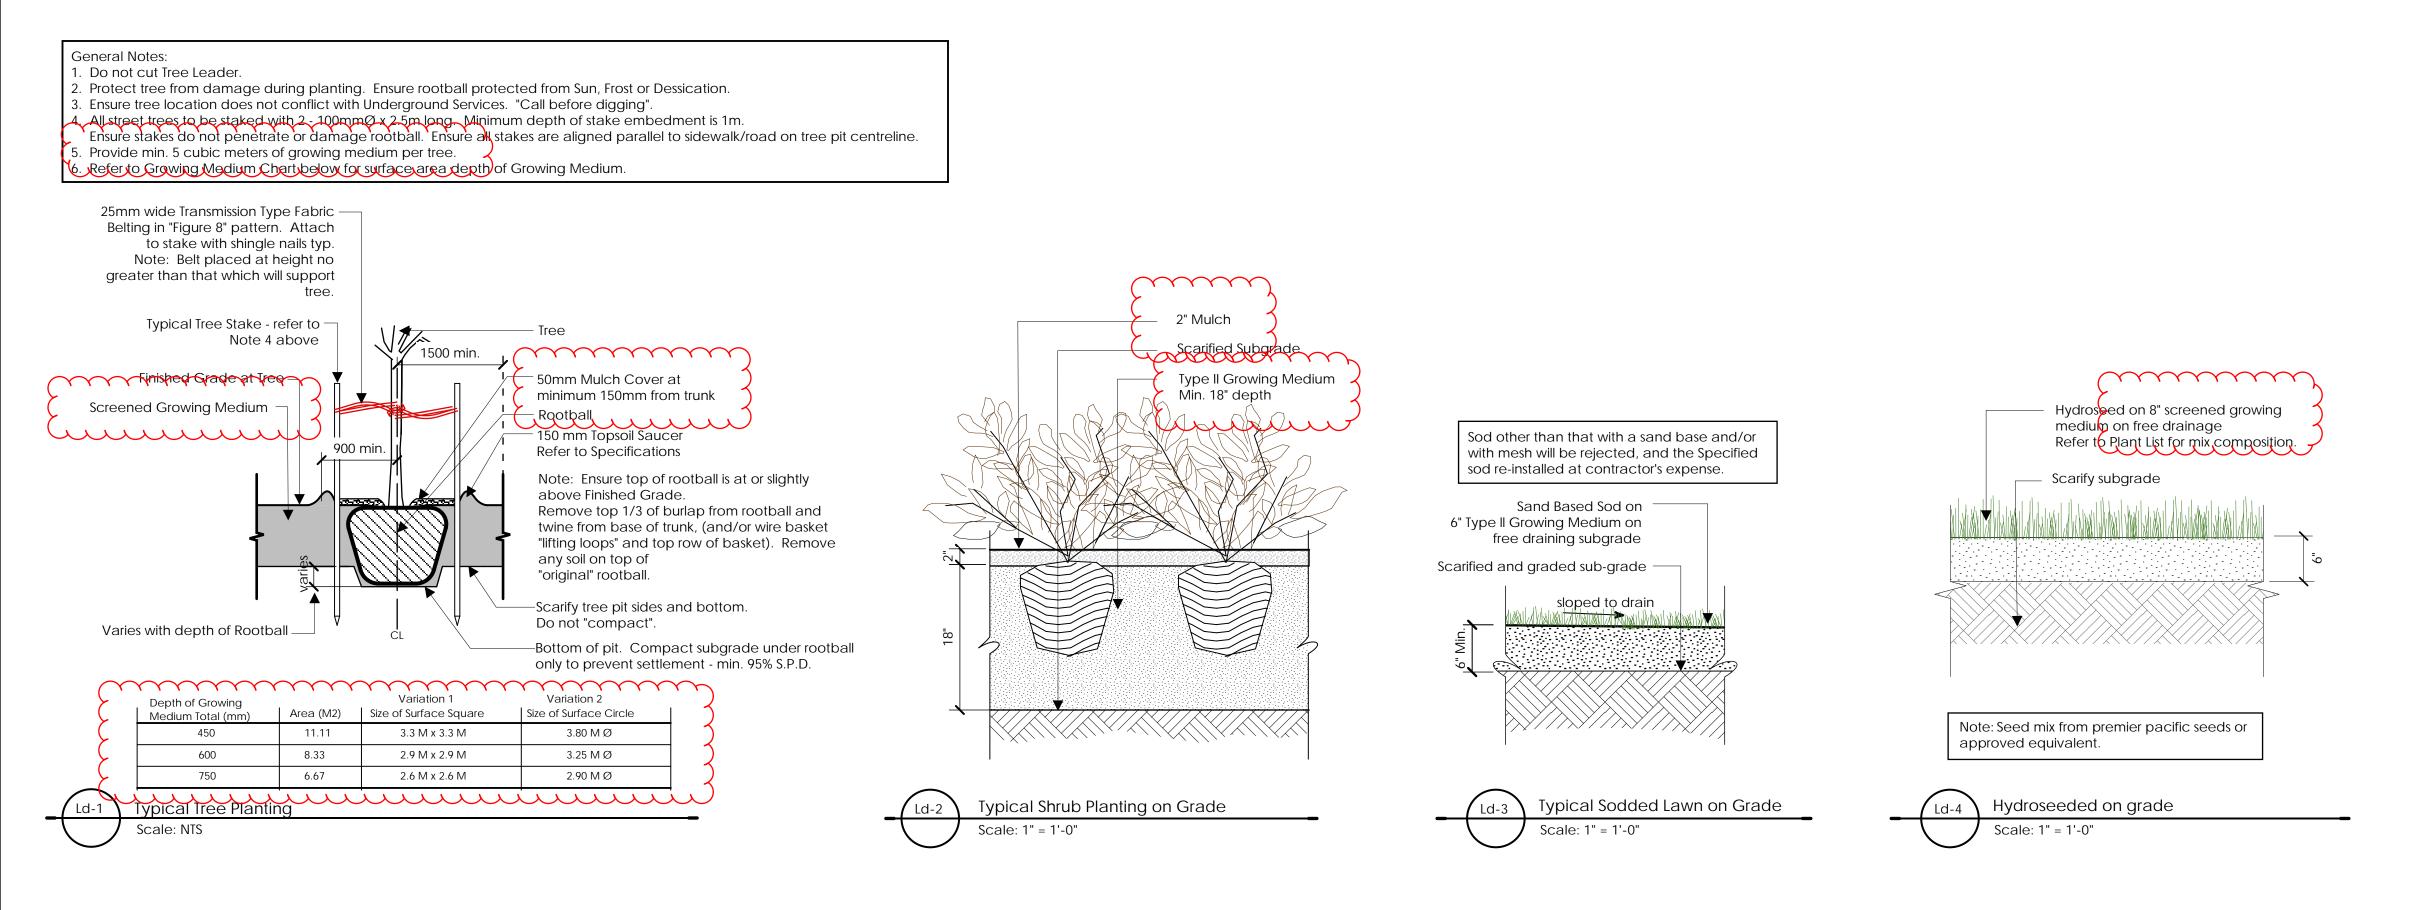
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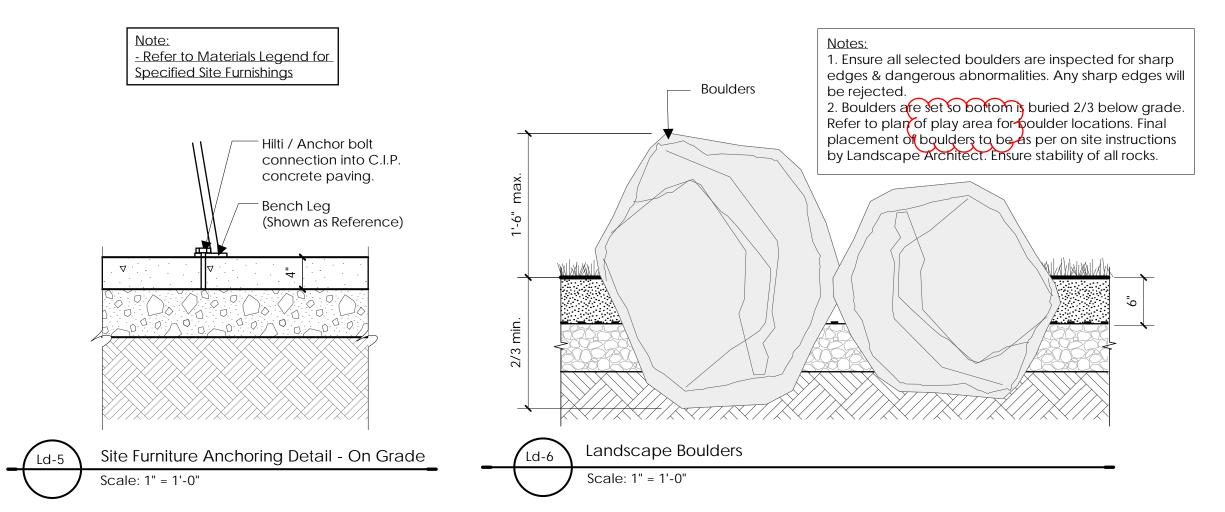
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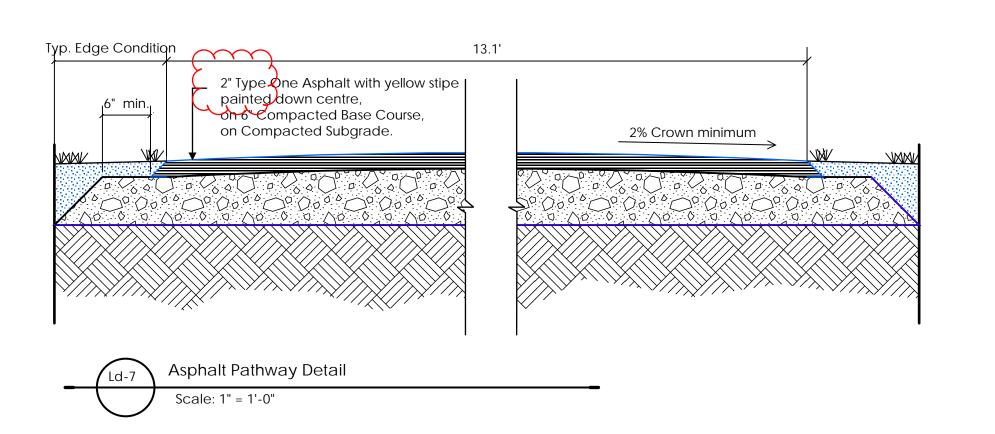
# Landscape Sections

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Custom Bench Precedent
Scale: NTS

Landscape Sections

As Shown

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Golden Ears Business Park
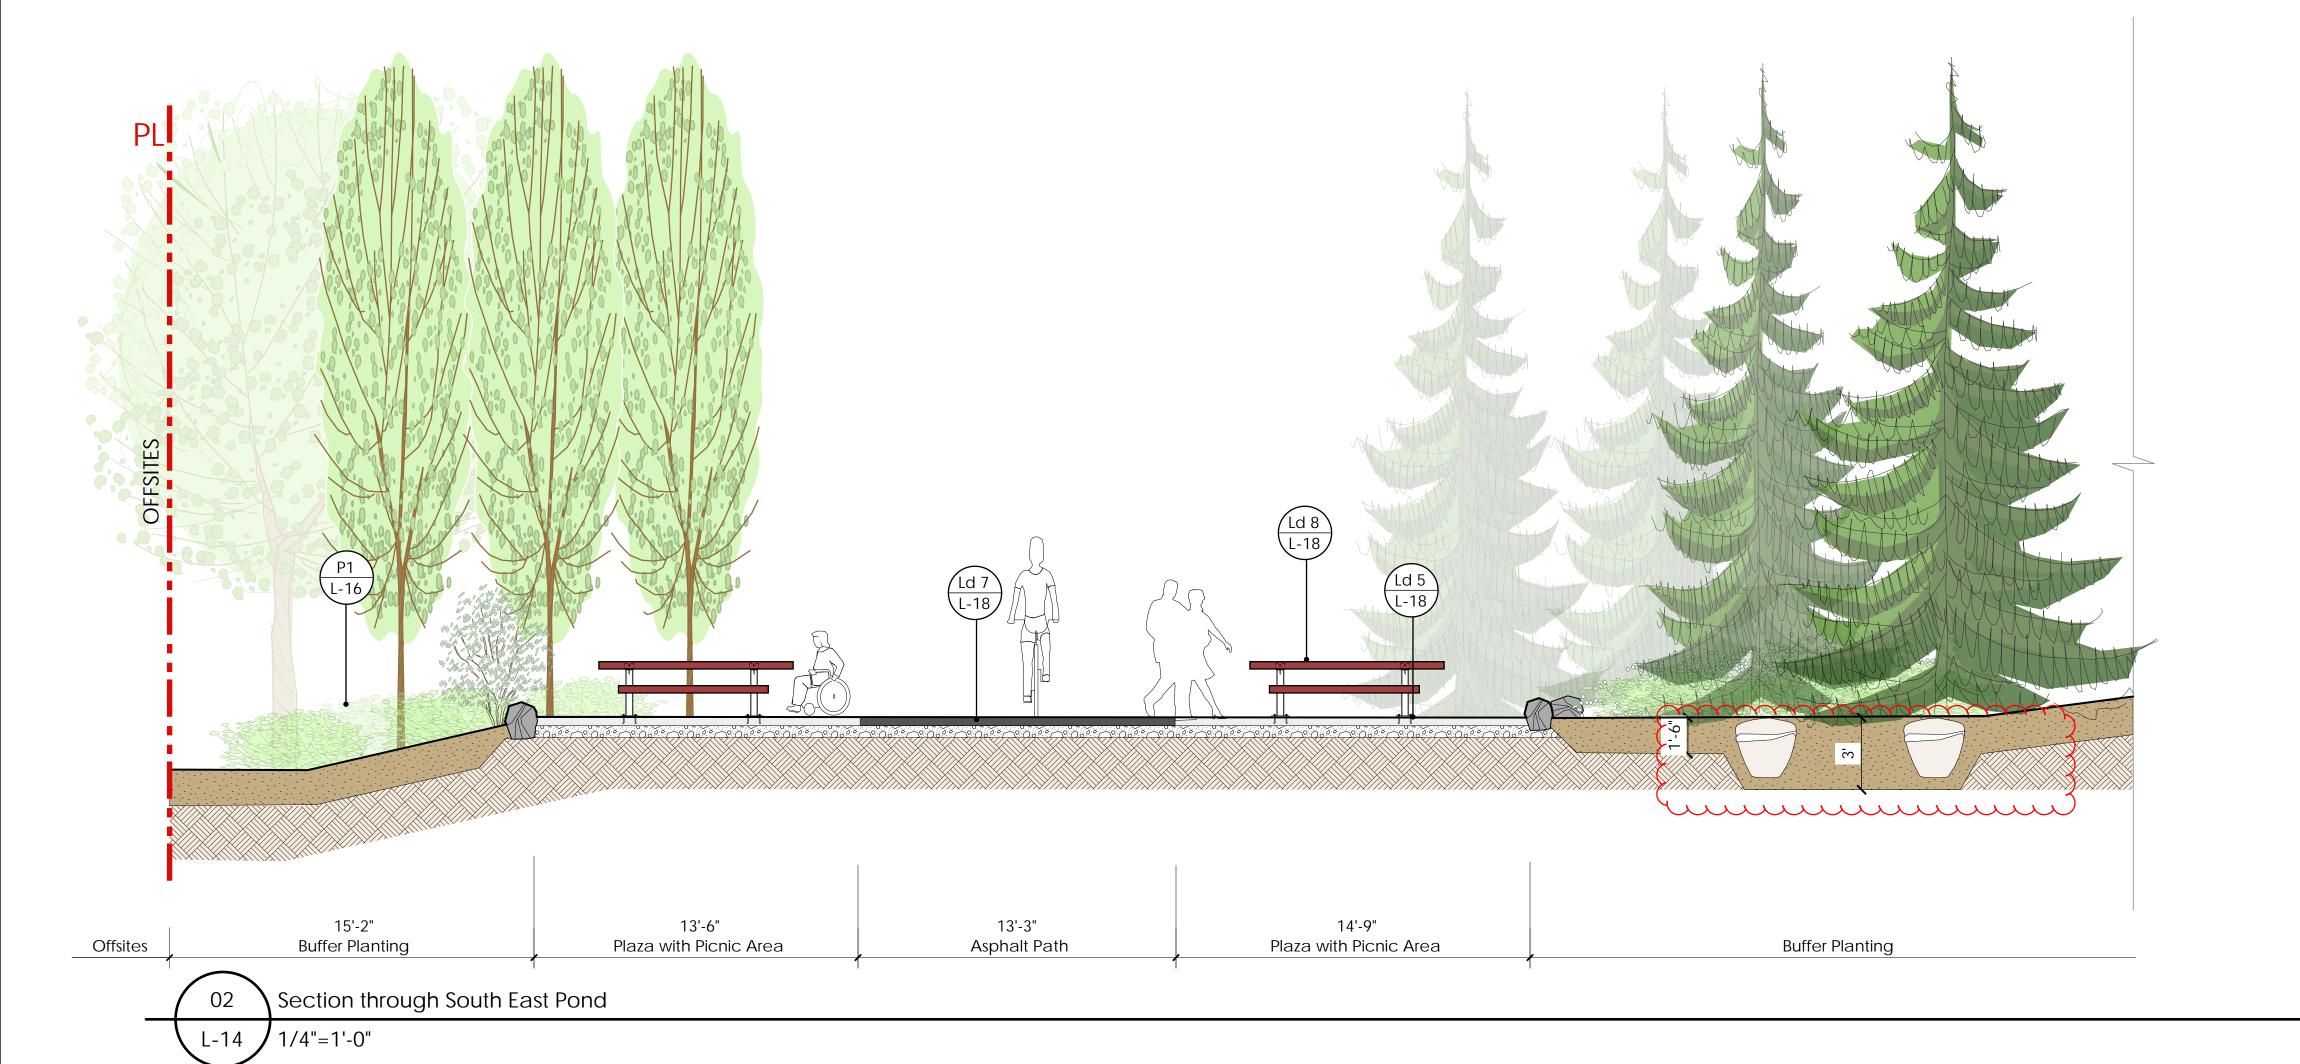
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